
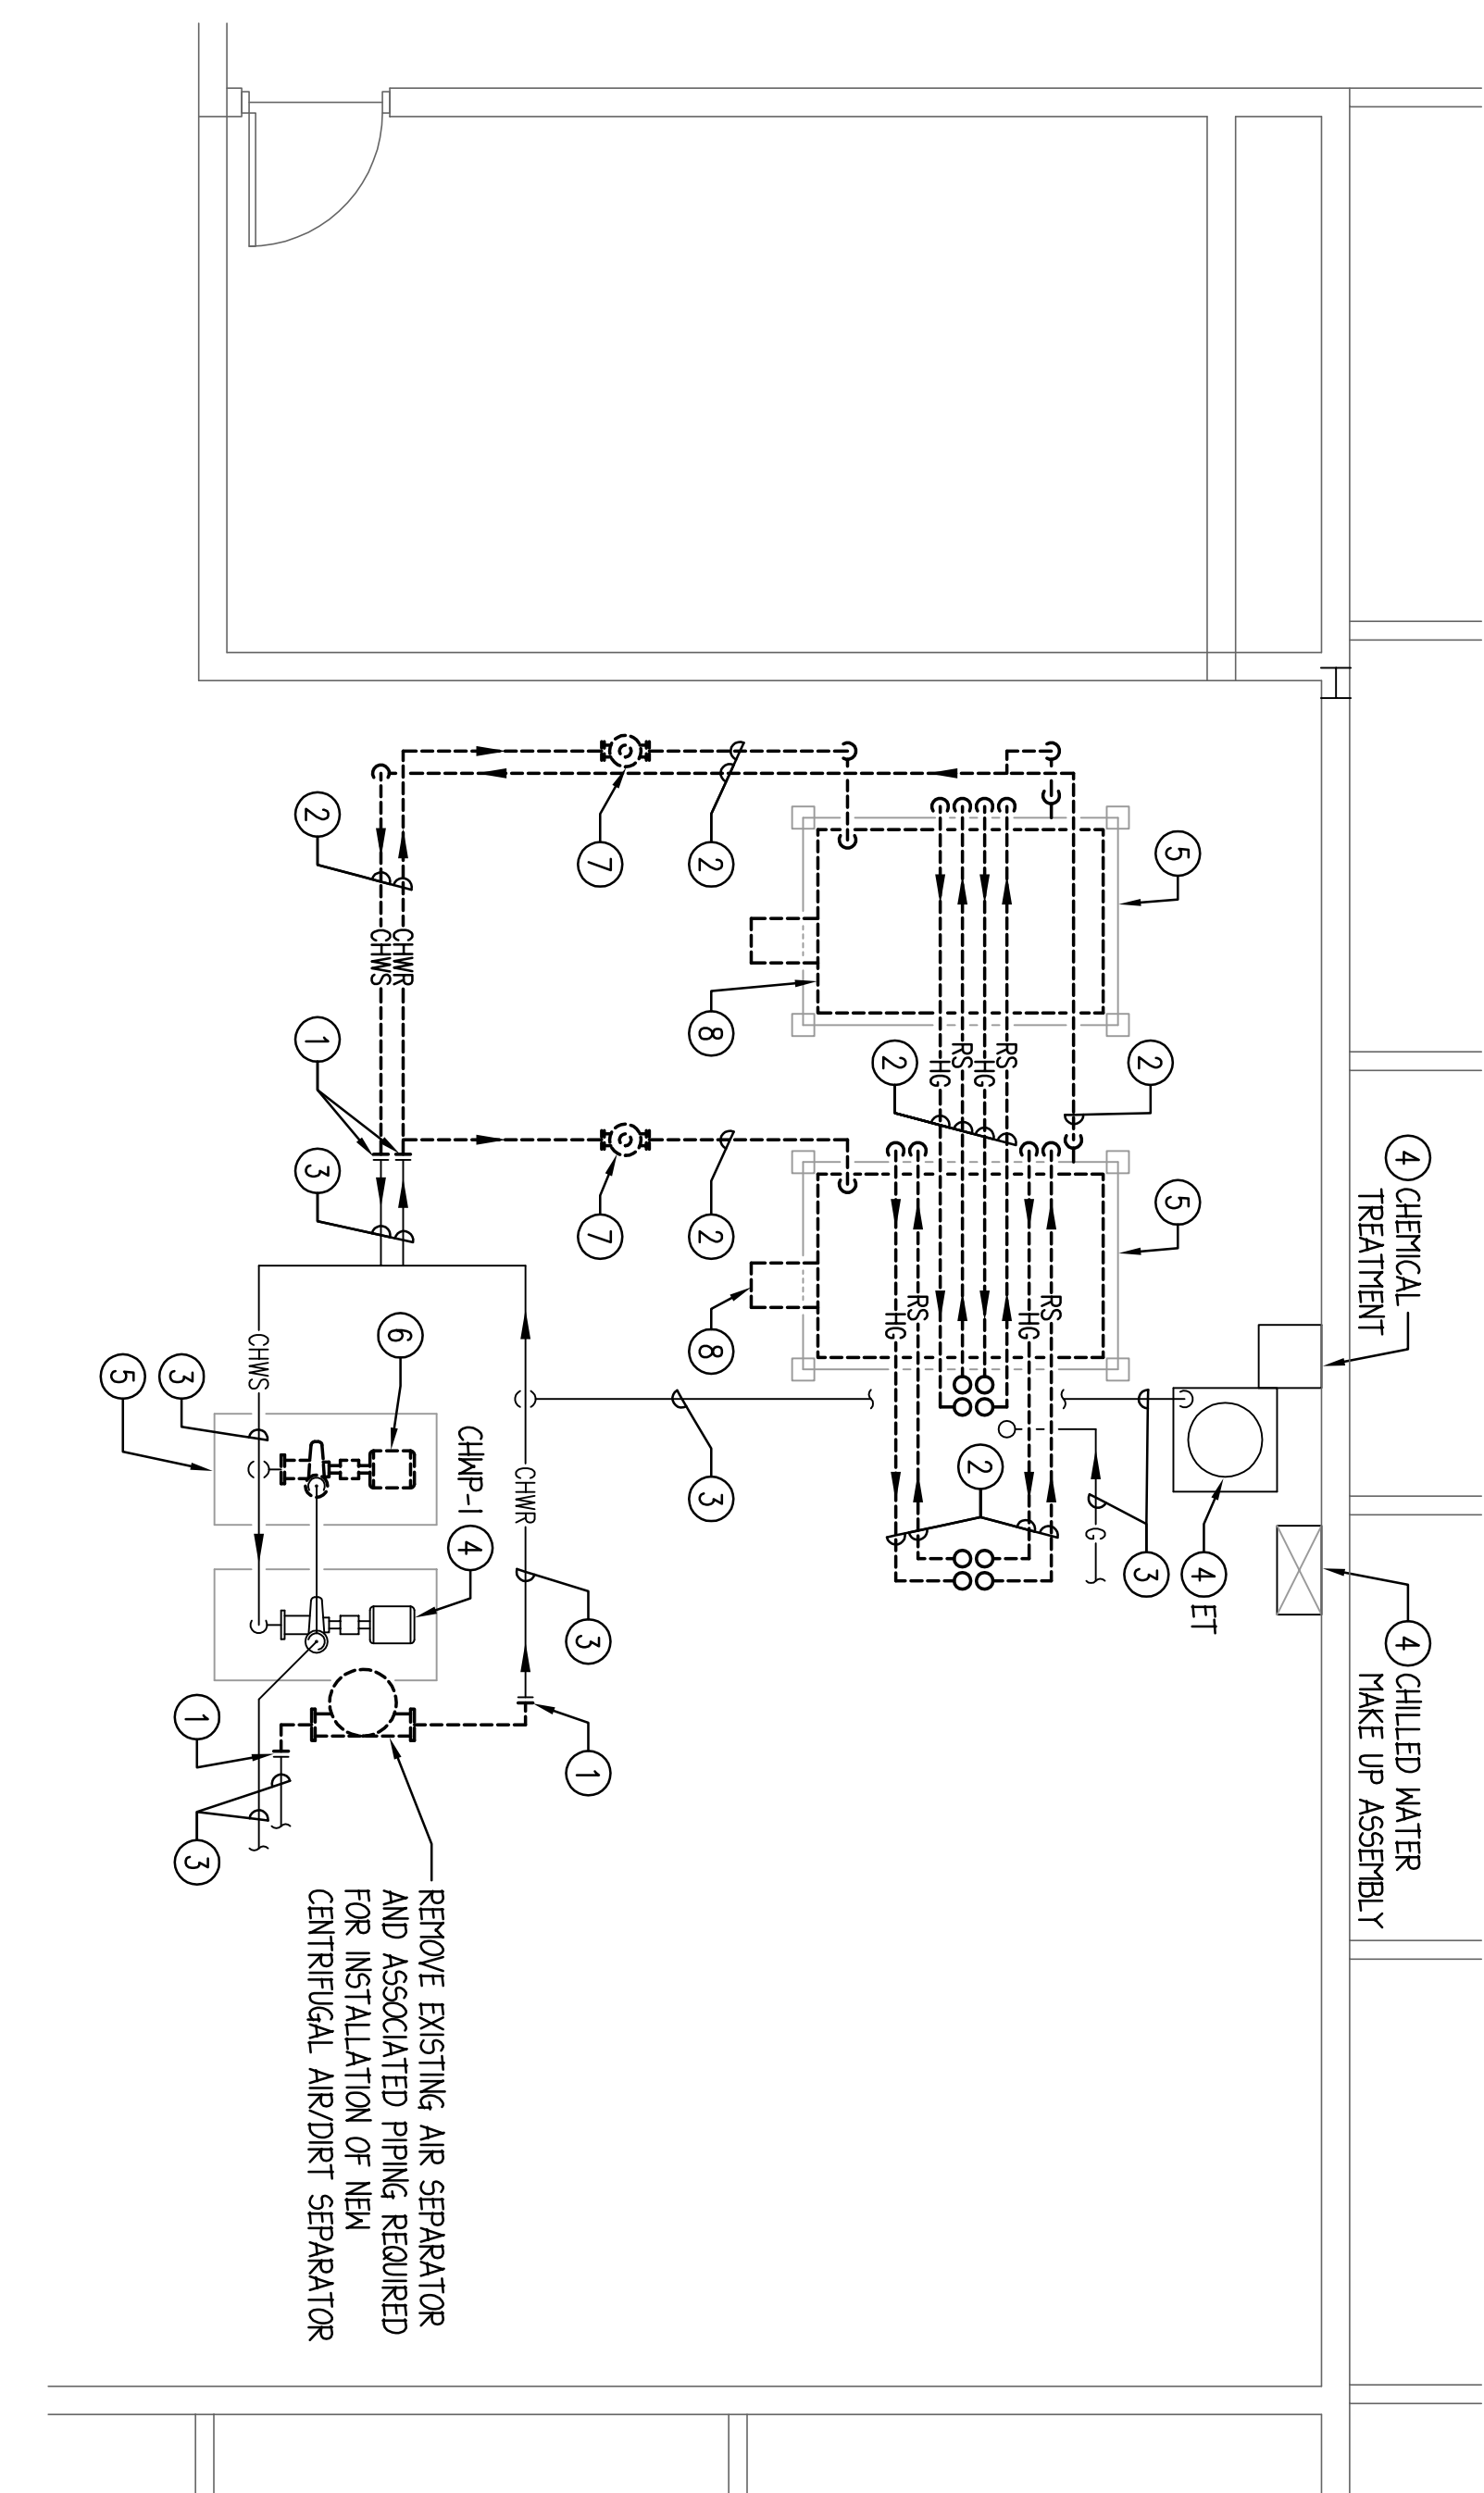


- DRAWING NOTES:** (TYPICAL FOR THIS DRAWING ONLY)
1. NEW CONNECTION TO BE MADE AT THIS LOCATION. REMOVE ALL PIPING, VALVING, HANGERS, INSULATION, ETC. SHOWN DASHED BEYOND THIS POINT.
 2. REMOVE ALL PIPING, VALVING, HANGERS, INSULATION, ETC. SHOWN DASHED.
 3. EXISTING PIPING AND VALVING TO REMAIN.
 4. EXISTING HVAC EQUIPMENT TO REMAIN.
 5. EXISTING SPRING ISOLATED INERTIA BASE TO REMAIN AND BE MODIFIED TO PROPERLY ACCEPT NEW EQUIPMENT. REPLACE SPRINGS IF REQUIRED BY NEW EQUIPMENT WEIGHTS/SIZES.
 6. REMOVE BASE MOUNTED PUMP.
 7. REMOVE INLINE PUMP AND ALL ASSOCIATED PIPING, VALVING, INSULATION, HANGERS, SUPPORTS, ETC.
 8. REMOVE CHILLER, AND ALL ASSOCIATED PIPING, VALVING, AND CONTROLS.
 9. MODIFY EXISTING CHILLED WATER PUMP TO PROPERLY INSTALL NEW EQUIPMENT.
 10. BALANCE EXISTING CHILLED WATER PUMP TO FLOW RATE INDICATED.
 11. TAKE NEW CONNECTION TO EXISTING PIPING AT THIS LOCATION.
 12. PIPE OF SIZE INDICATED UP THRU EXISTING ROOF PORTAL. PROVIDE NEW ASBESTOS FLEET PROOF CAP AND SUPPORT NEW PIPING ABOVE AND BELOW ROOF.
 13. PIPE OVER TO NEAREST FLOOR DRAIN.
 14. PROVIDE PASSAGION OF UNIT AS DIRECTED BY MANUFACTURER.
 15. SEE DETAIL ON SHEET HV-4.

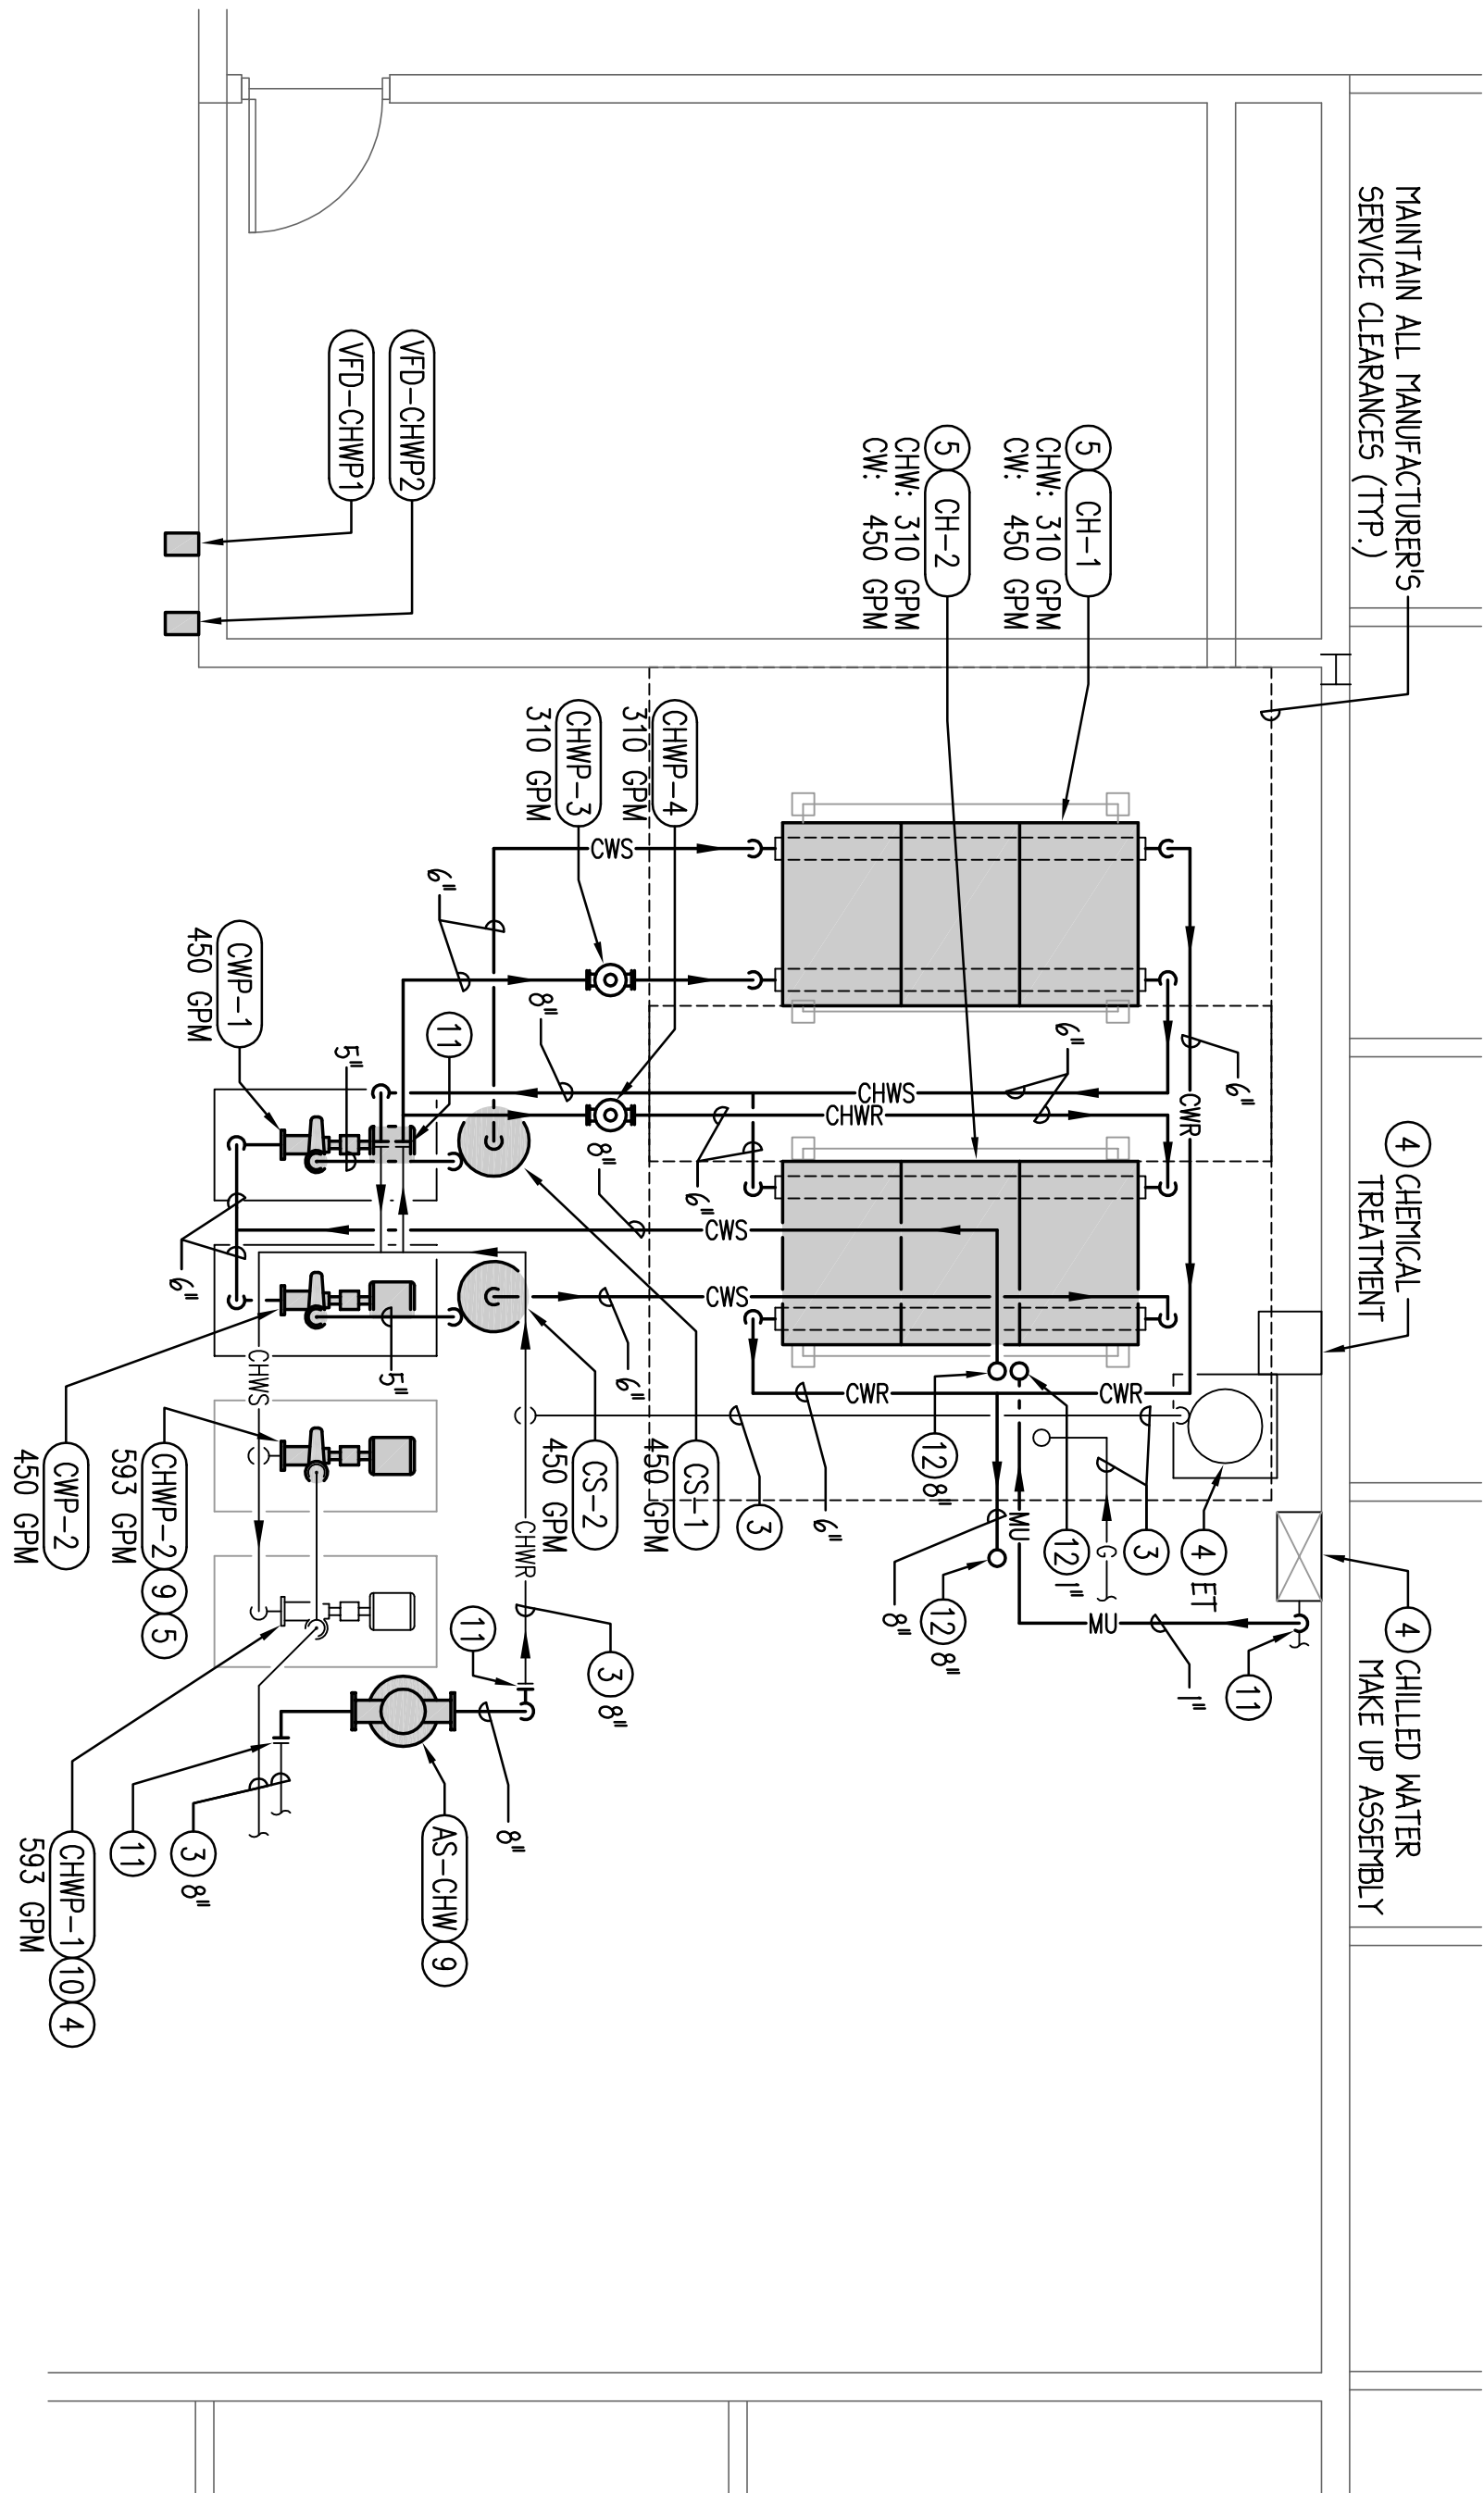

BIDDING NOTES:

BASE BID: DELETE THIS SHEET IN IT'S ENTIRETY.
ALT. BID #2: PROVIDE ALL WORK SHOWN ON THIS SHEET.



BIDDING NOTES:

TEMPERATURE CONTROL: ALL TEMPERATURE CONTROL WORK SHALL BE BY TRADE CONTRACTS UNDER SEPARATE BAS CONTRACT.

ALT. BID #1: PROVIDE NEW DIFFERENTIAL PRESSURE SENSOR IN CHILLED WATER PUMP SYSTEM (AT LOCATION OF T.C. CONTRACTORS CHOOSING) AND REPLACE THE FOLLOWING 3-WAY CHILLED WATER VALVES WITH 2-WAY VALVES AS FOLLOWS (FIELD VERIFY ALL EXISTING SIZES):

- AHU-1: 4" 1712 GPM
- AHU-2: 2" 161 GPM
- AHU-3: 3" 161 GPM
- AHU-4: 4" 161 GPM
- AHU-5: 2" 161 GPM
- AHU-6: 2" 161 GPM
- AHU-7: 2" 161 GPM
- AHU-8: 2" 161 GPM
- AHU-9: 2" 161 GPM
- AHU-10: 2" 161 GPM
- AHU-11: 2" 161 GPM
- AHU-12: 2" 161 GPM
- AHU-13: 2" 161 GPM
- AHU-14: 2" 161 GPM
- AHU-15: 2" 161 GPM
- AHU-16: 2" 161 GPM
- AHU-17: 2" 161 GPM
- AHU-18: 2" 161 GPM
- AHU-19: 2" 161 GPM
- AHU-20: 2" 161 GPM
- AHU-21: 2" 161 GPM
- AHU-22: 2" 161 GPM
- AHU-23: 2" 161 GPM
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- AHU-34: 2" 161 GPM
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- AHU-96: 2" 161 GPM
- AHU-97: 2" 161 GPM
- AHU-98: 2" 161 GPM
- AHU-99: 2" 161 GPM
- AHU-100: 2" 161 GPM

CAP INSTALLED BY TRADE CONTRACTOR. CAP TO BE FINISHED AND WIRED BY T.C. CONTRACTOR AND INSTALLED BY HVAC CONTRACTOR.

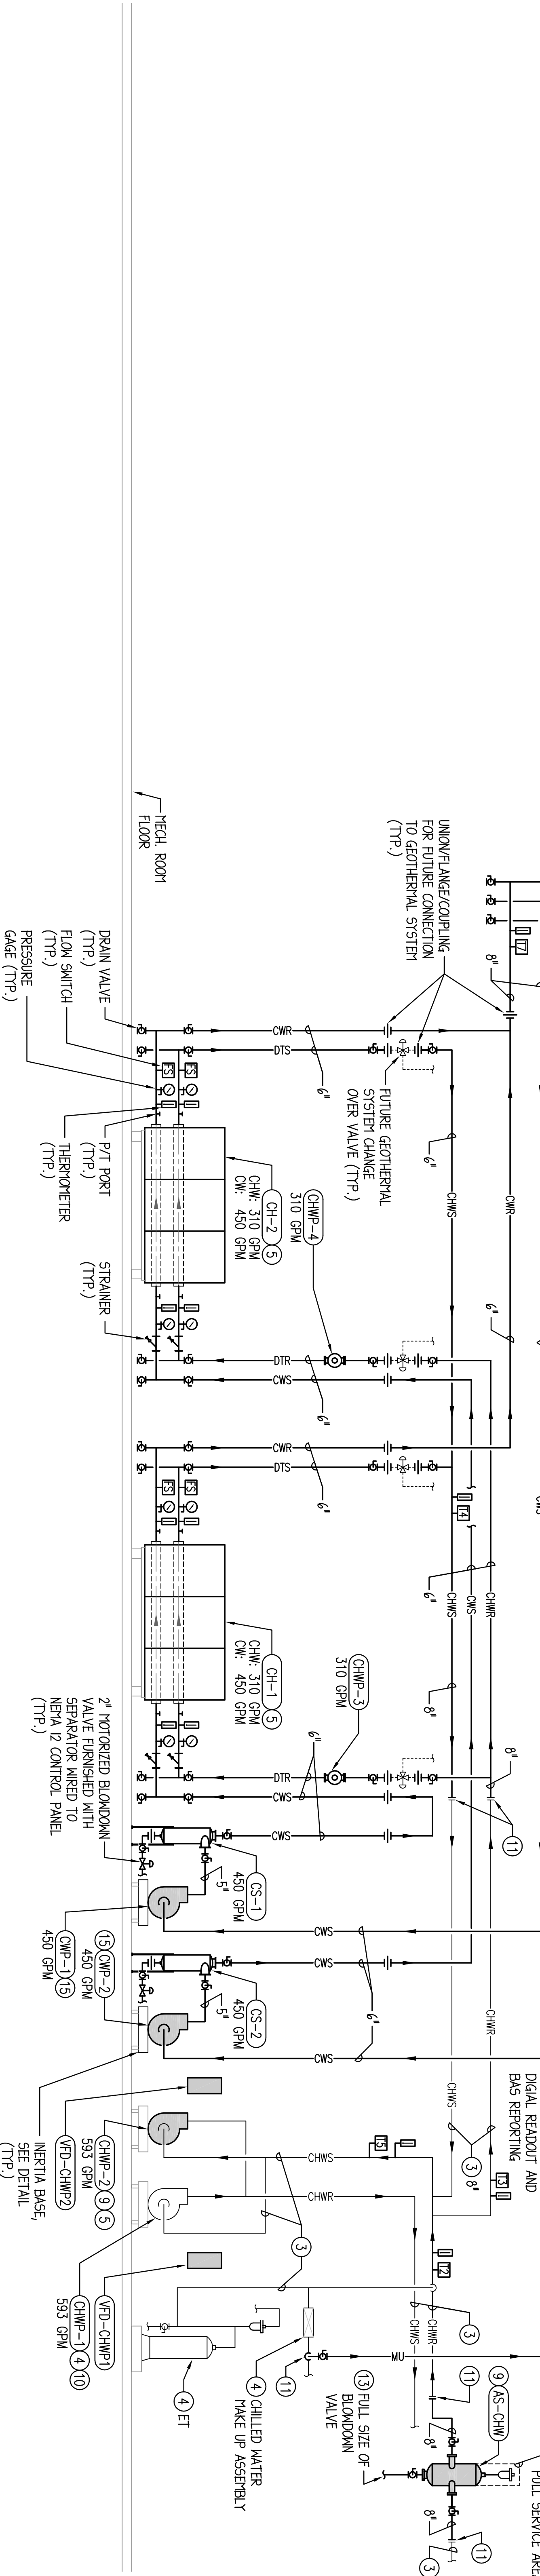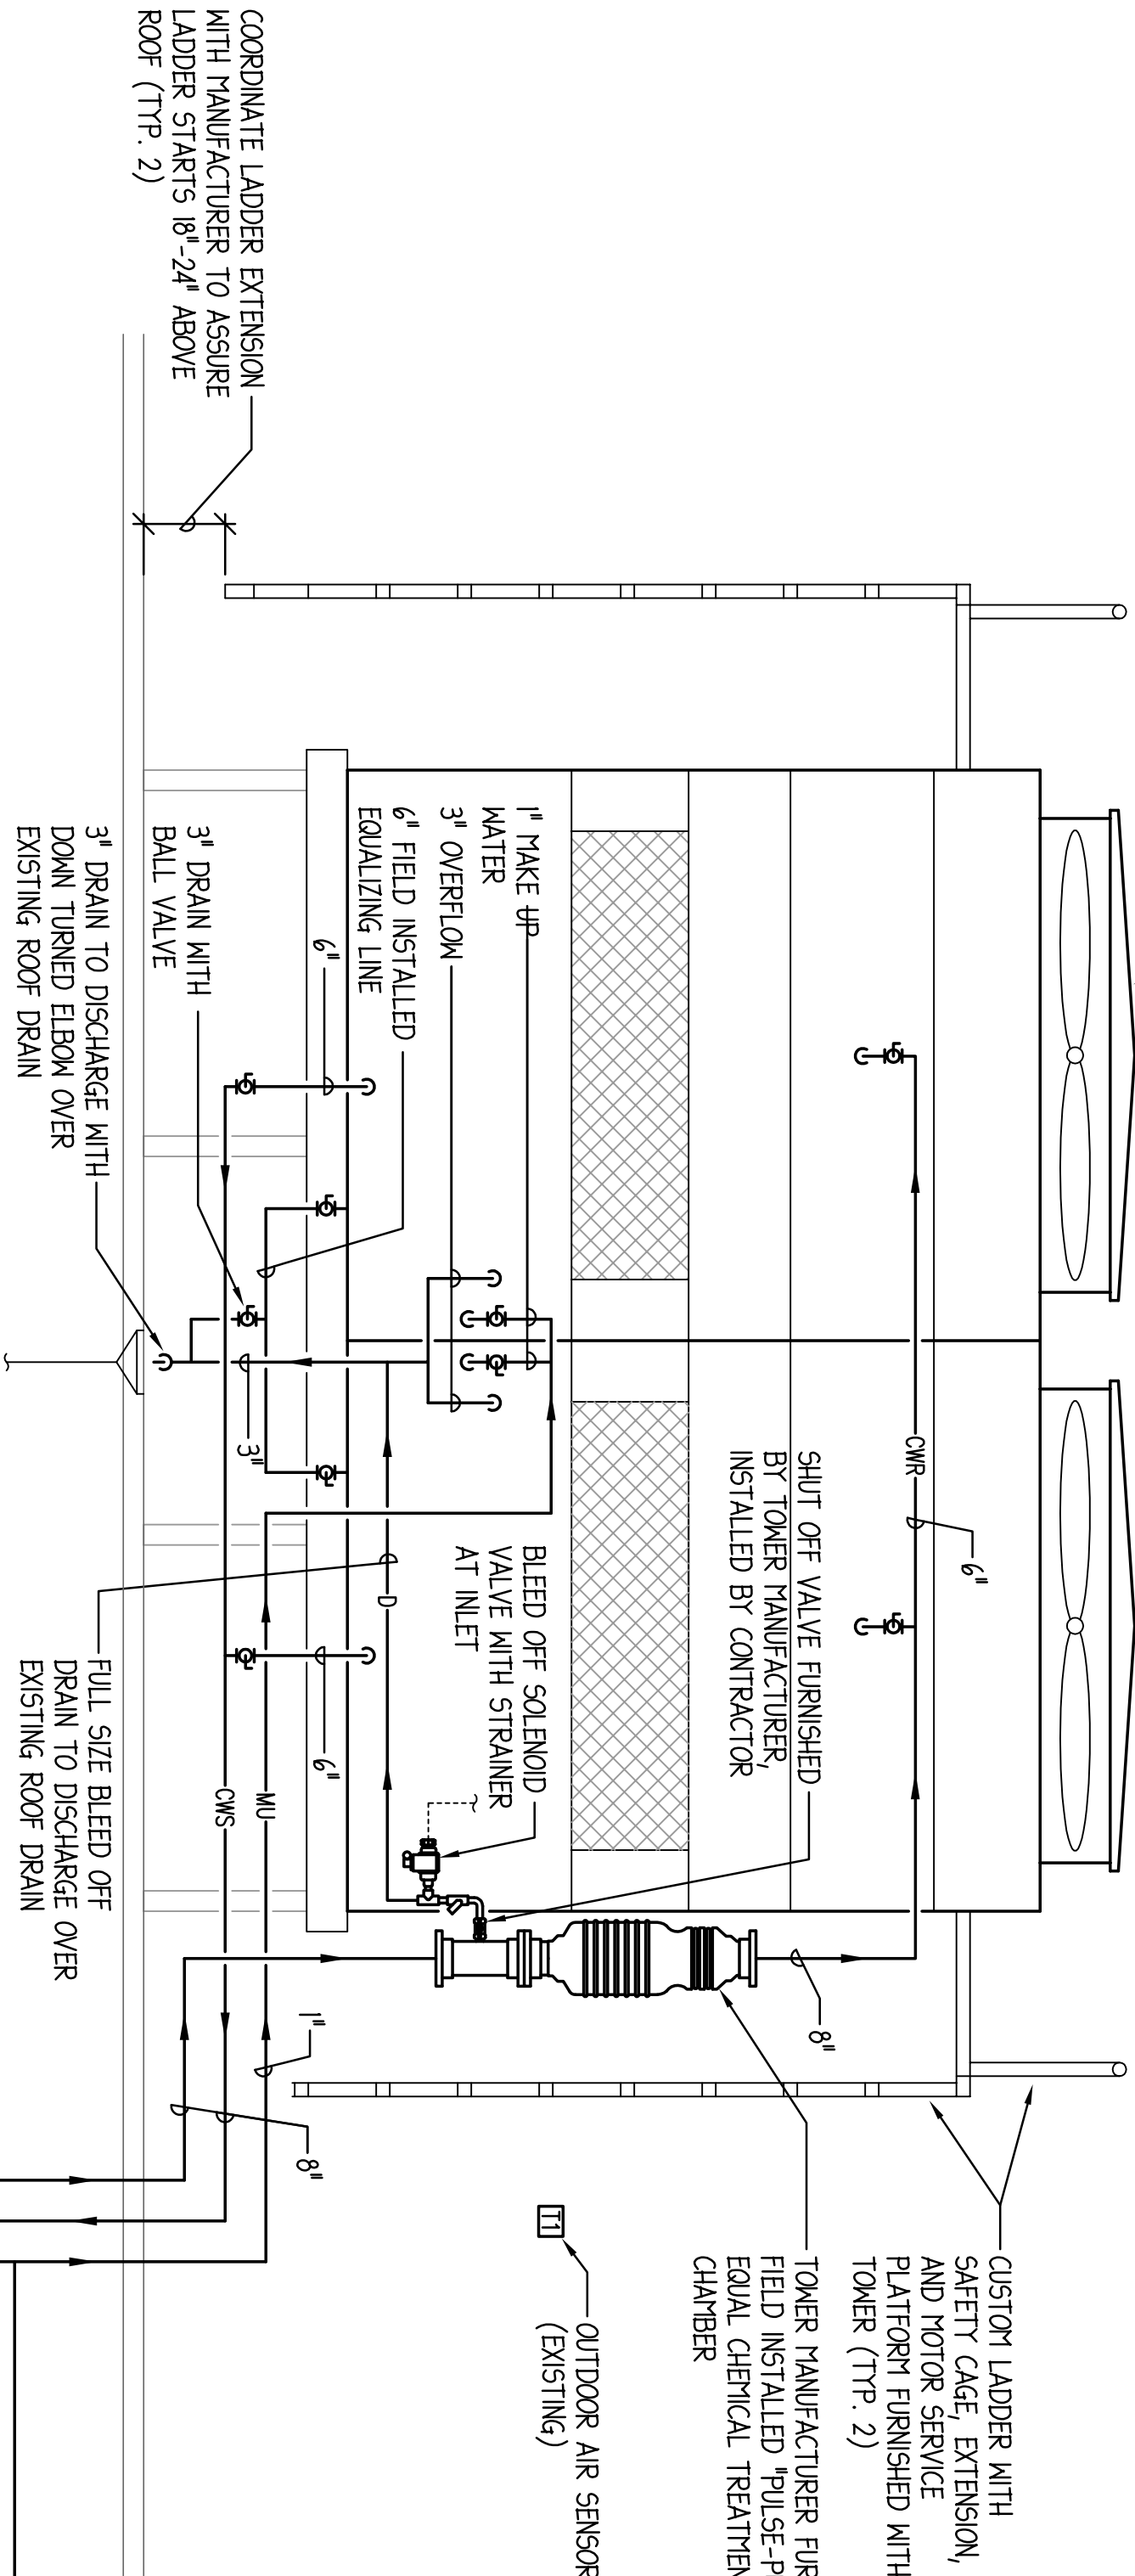

SCHEMATIC PIPING DIAGRAM
NO SCALE

Revisions:
23 JUNE 2014 - BID DOCUMENTS

McHenry County College - Building 'B' Chiller Replacement
8900 US Hwy 14 - Building 'B'
Crystal Lake, Illinois 60012

ALT. BID #2: MECHANICAL ROOM HVAC
PLANS AND RISER DIAGRAM


Consultants:
Mechanical - Electrical - Structural Engineers
1216 Tower Road
Schaumburg, Illinois 60173
847.882.2010
Fax 847.882.2201



HV-2

Issue Date:
20 JUNE 2014
Drawn By:
20/10
Job Number:
1600-A-3


- DRAWING NOTES:** (TYPICAL FOR THIS DRAWING ONLY)
- 1 REMOVE ALL PIPING, VALVING, HANGERS, INSULATION, ETC. SHOWN DASHED.
 - 2 EXISTING PIPING AND VALVING TO REMAIN.
 - 3 EXISTING HVAC EQUIPMENT TO REMAIN.
 - 4 EXISTING ROOF SUPPORTS TO REMAIN AND BE MODIFIED TO PROPERLY ACCEPT NEW EQUIPMENT.
 - 5 REMOVE AIR COOLED CONDENSER AND ALL ASSOCIATED PIPING, VALVING, AND CONTROLS.
 - 6 REFRIGERANT PIPING SIZE IN STRICT ACCORDANCE WITH CHILLER MANUFACTURER'S INSTRUCTION.

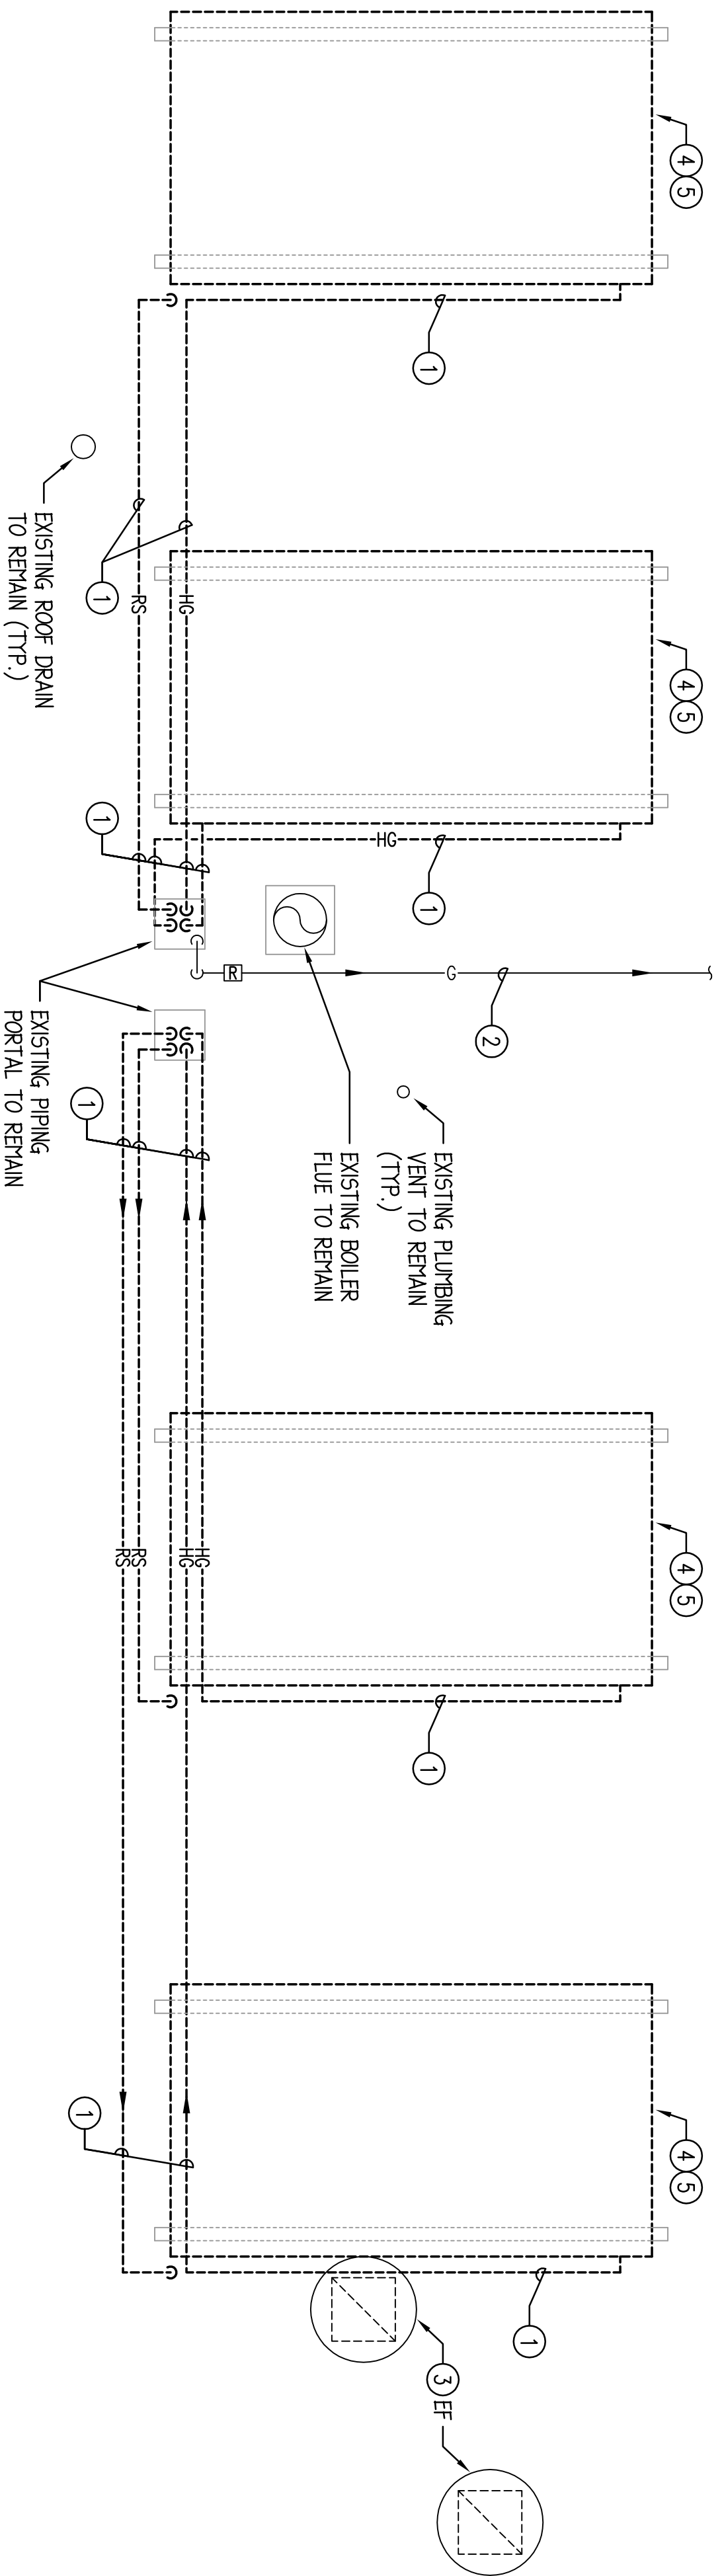


EXISTING INTAKE/
RELIEF/EXHAUST
FAN TO REMAIN
(TYP.)

EXISTING BOILER
FLUE TO REMAIN
(TYP.)

1 BASE BID & ALT. BID #2: HVAC ROOF DEMOLITION PLAN
1/4" = 1'-0"

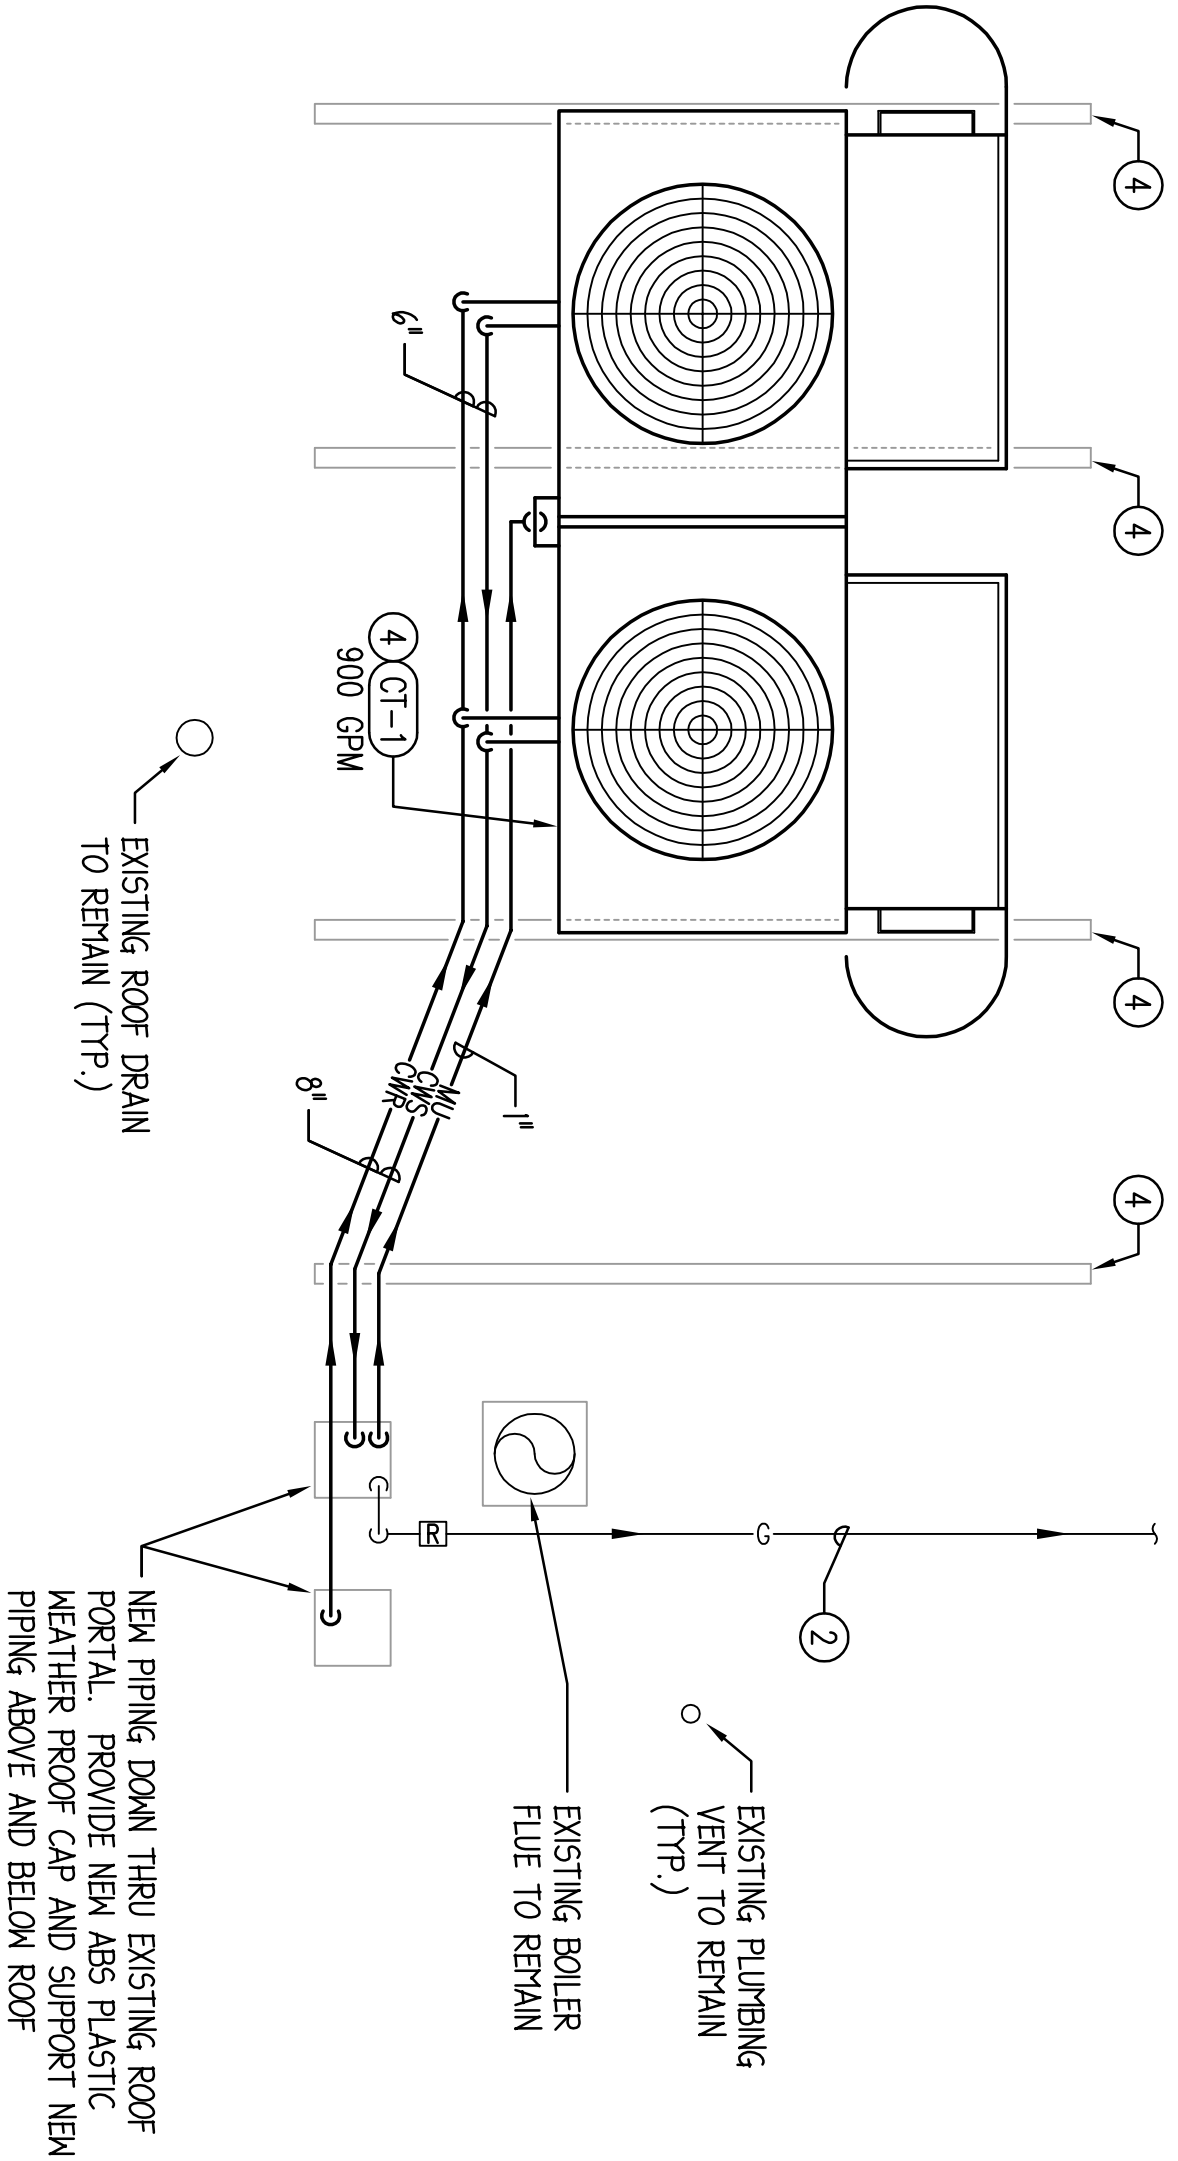

2 ALT. BID #2: HVAC ROOF PLAN
1/4" = 1'-0"

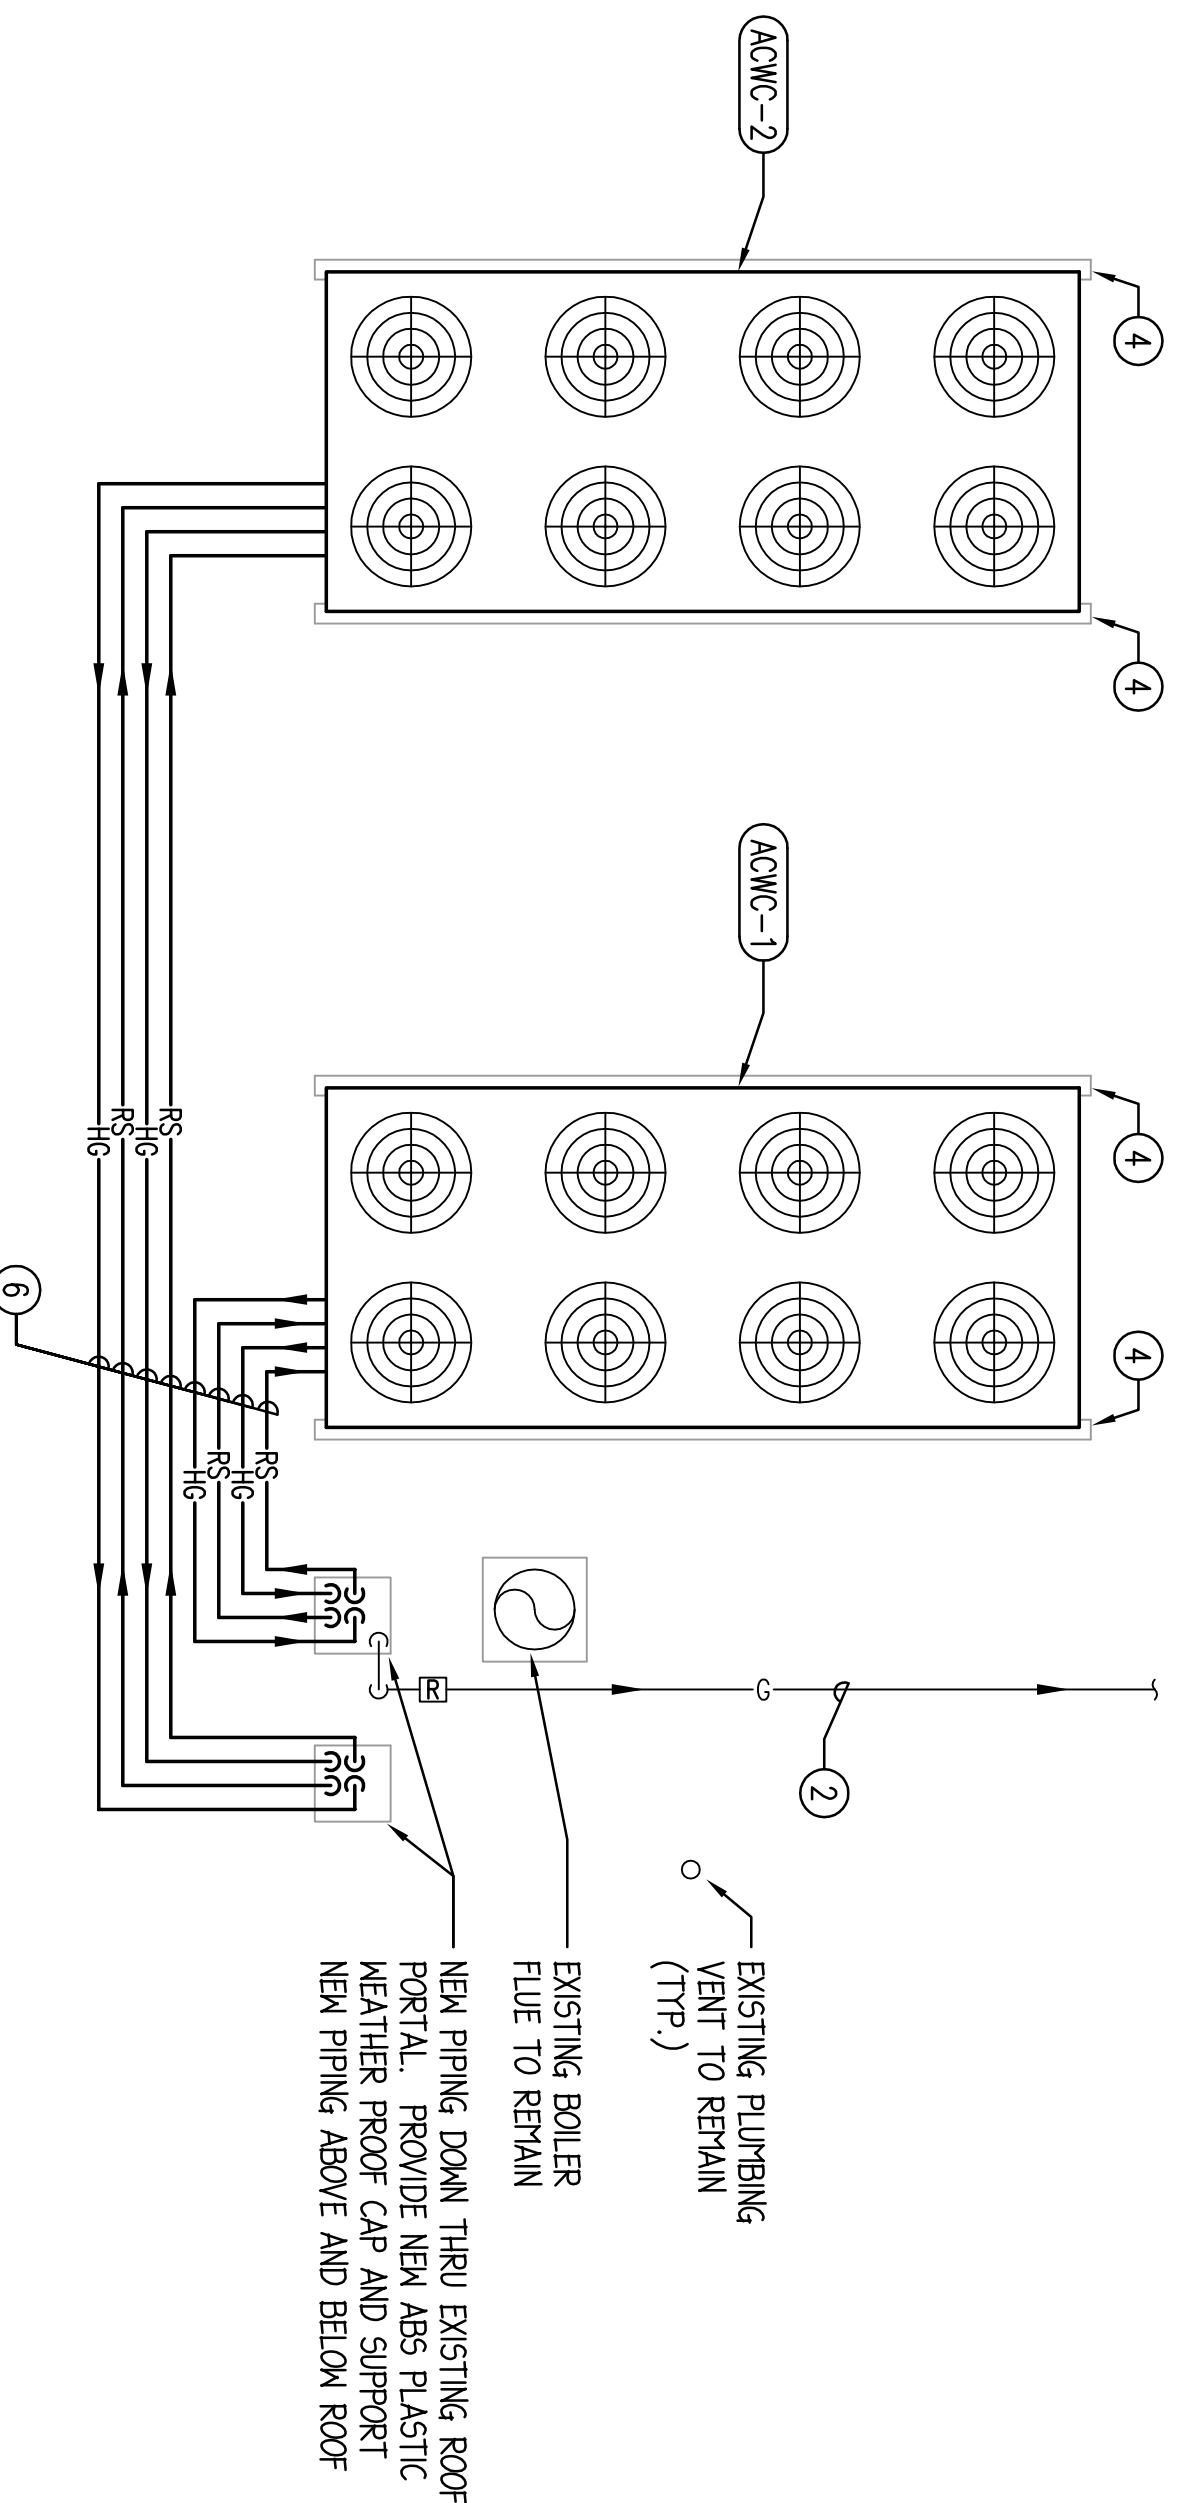

2 BASE BID: HVAC ROOF PLAN
1/4" = 1'-0"

Consultants:
Mechanical - Electrical - Structural Engineers
1216 Tower Road
Schaumburg, Illinois 60173
847.882.2010
Fax 847.882.2201
2010 ENGINEERING GROUP LLC


HVAC DEMOLITION AND NEW WORK ROOF PLANS

McHenry County College - Building 'B' Chiller Replacement
8900 US Hwy 14 - Building 'B'
Crystal Lake, Illinois 60012

Revisions:
23 JUNE 2014 - BID DOCUMENTS

Issue Date:
18 JUNE 2014
Drawn By:
20/10
Job Number:
1600-A-3

HV-3

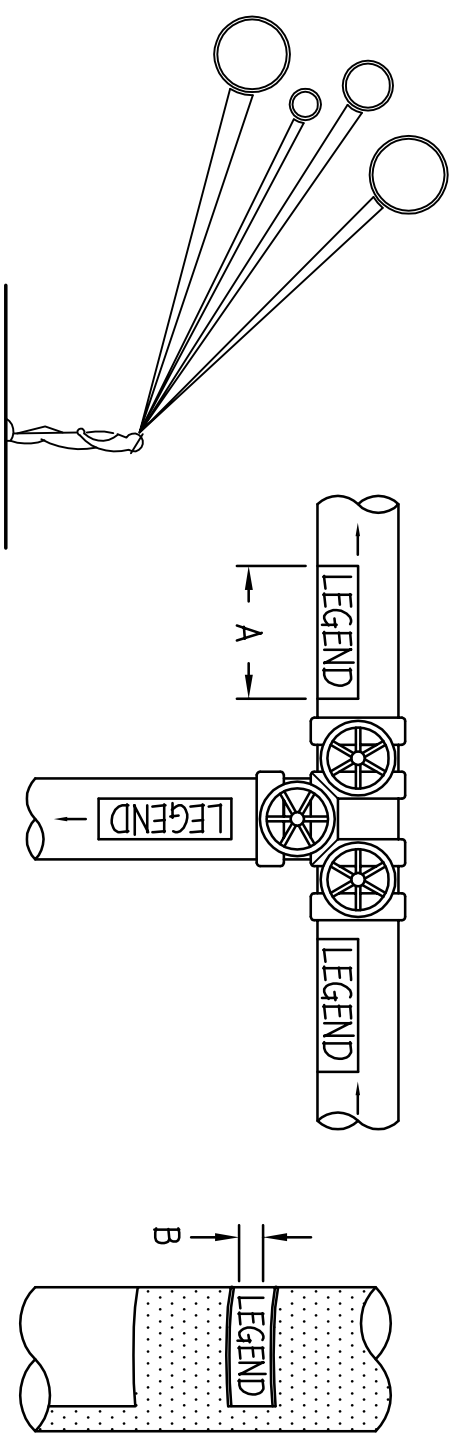


NOTE: IDENTIFICATION MARKERS OR STRIPS TO BE PLACED ON ALL EXPOSED COVERED AND UNCOVERED PIPES AT 50'-0" INTERVALS, ADJACENT TO ALL VALVES OR BRANCHES, AND AT BOTH SIDES OF WALL/FLOOR PENETRATIONS. ARROWS OF SAME COLOR AS IDENTIFICATION MARKERS SHALL ALSO BE PLACED ON PIPES POINTING AWAY FROM MARKER INDICATING DIRECTION OF FLOW.

SIZE OF LEGEND LETTERS		
OUTSIDE DIAMETER OF PIPE OR COVERING	LENGTH OF COLOR FIELD A	SIZE OF LETTERS B
3/4" TO 1 1/4"	8"	1/2"
1 1/2" TO 2"	8"	3/4"
2 1/2" TO 6"	12"	1 1/4"


TYPICAL PIPE IDENTIFICATION MARKERS

NO SCALE

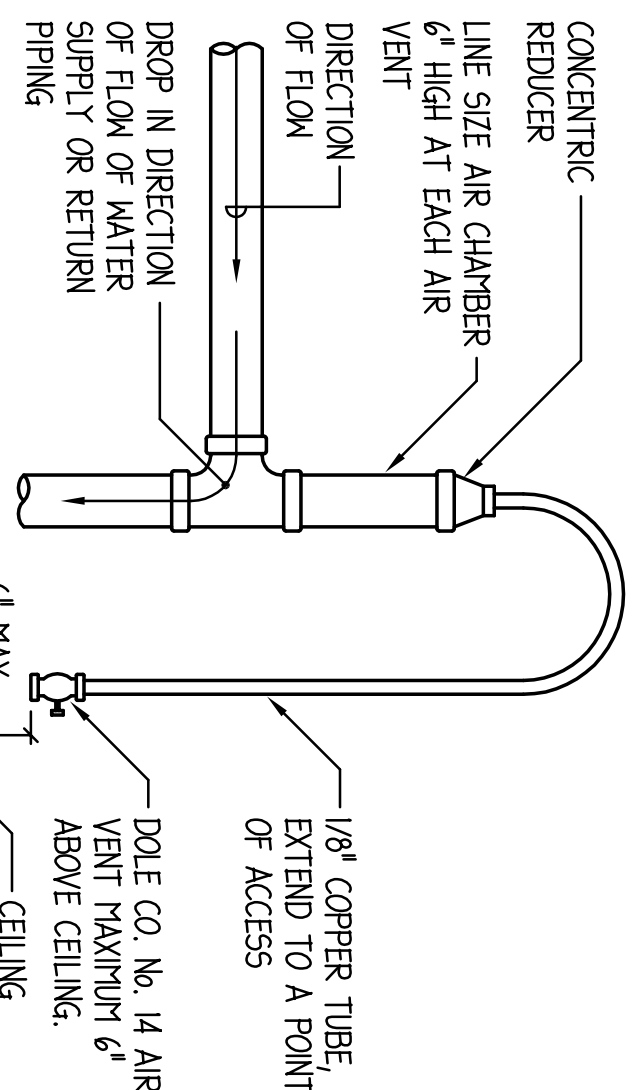


MANUAL AIR VENT DETAIL

NO SCALE

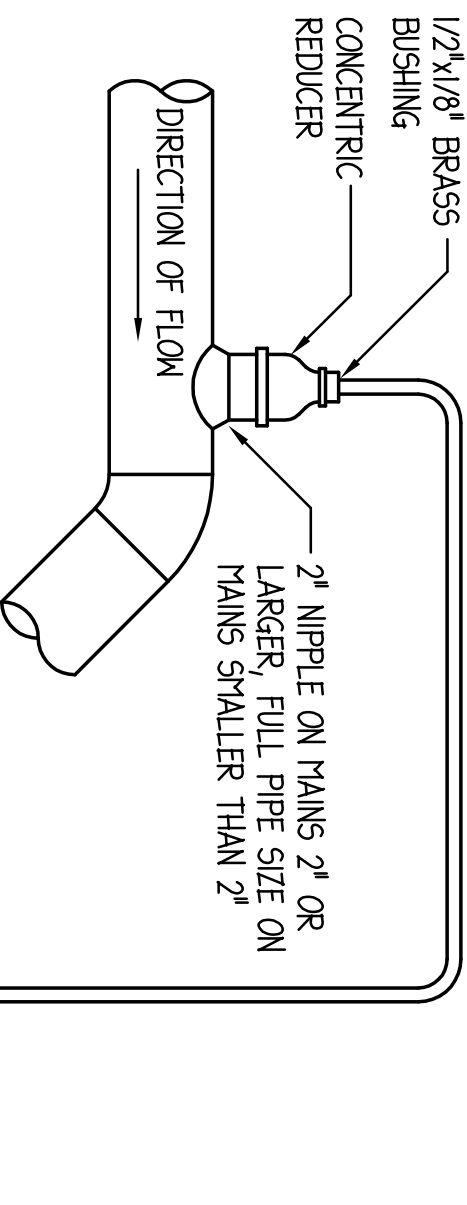

AIR VENT AT HIGH POINTS OF MAINS


NO SCALE

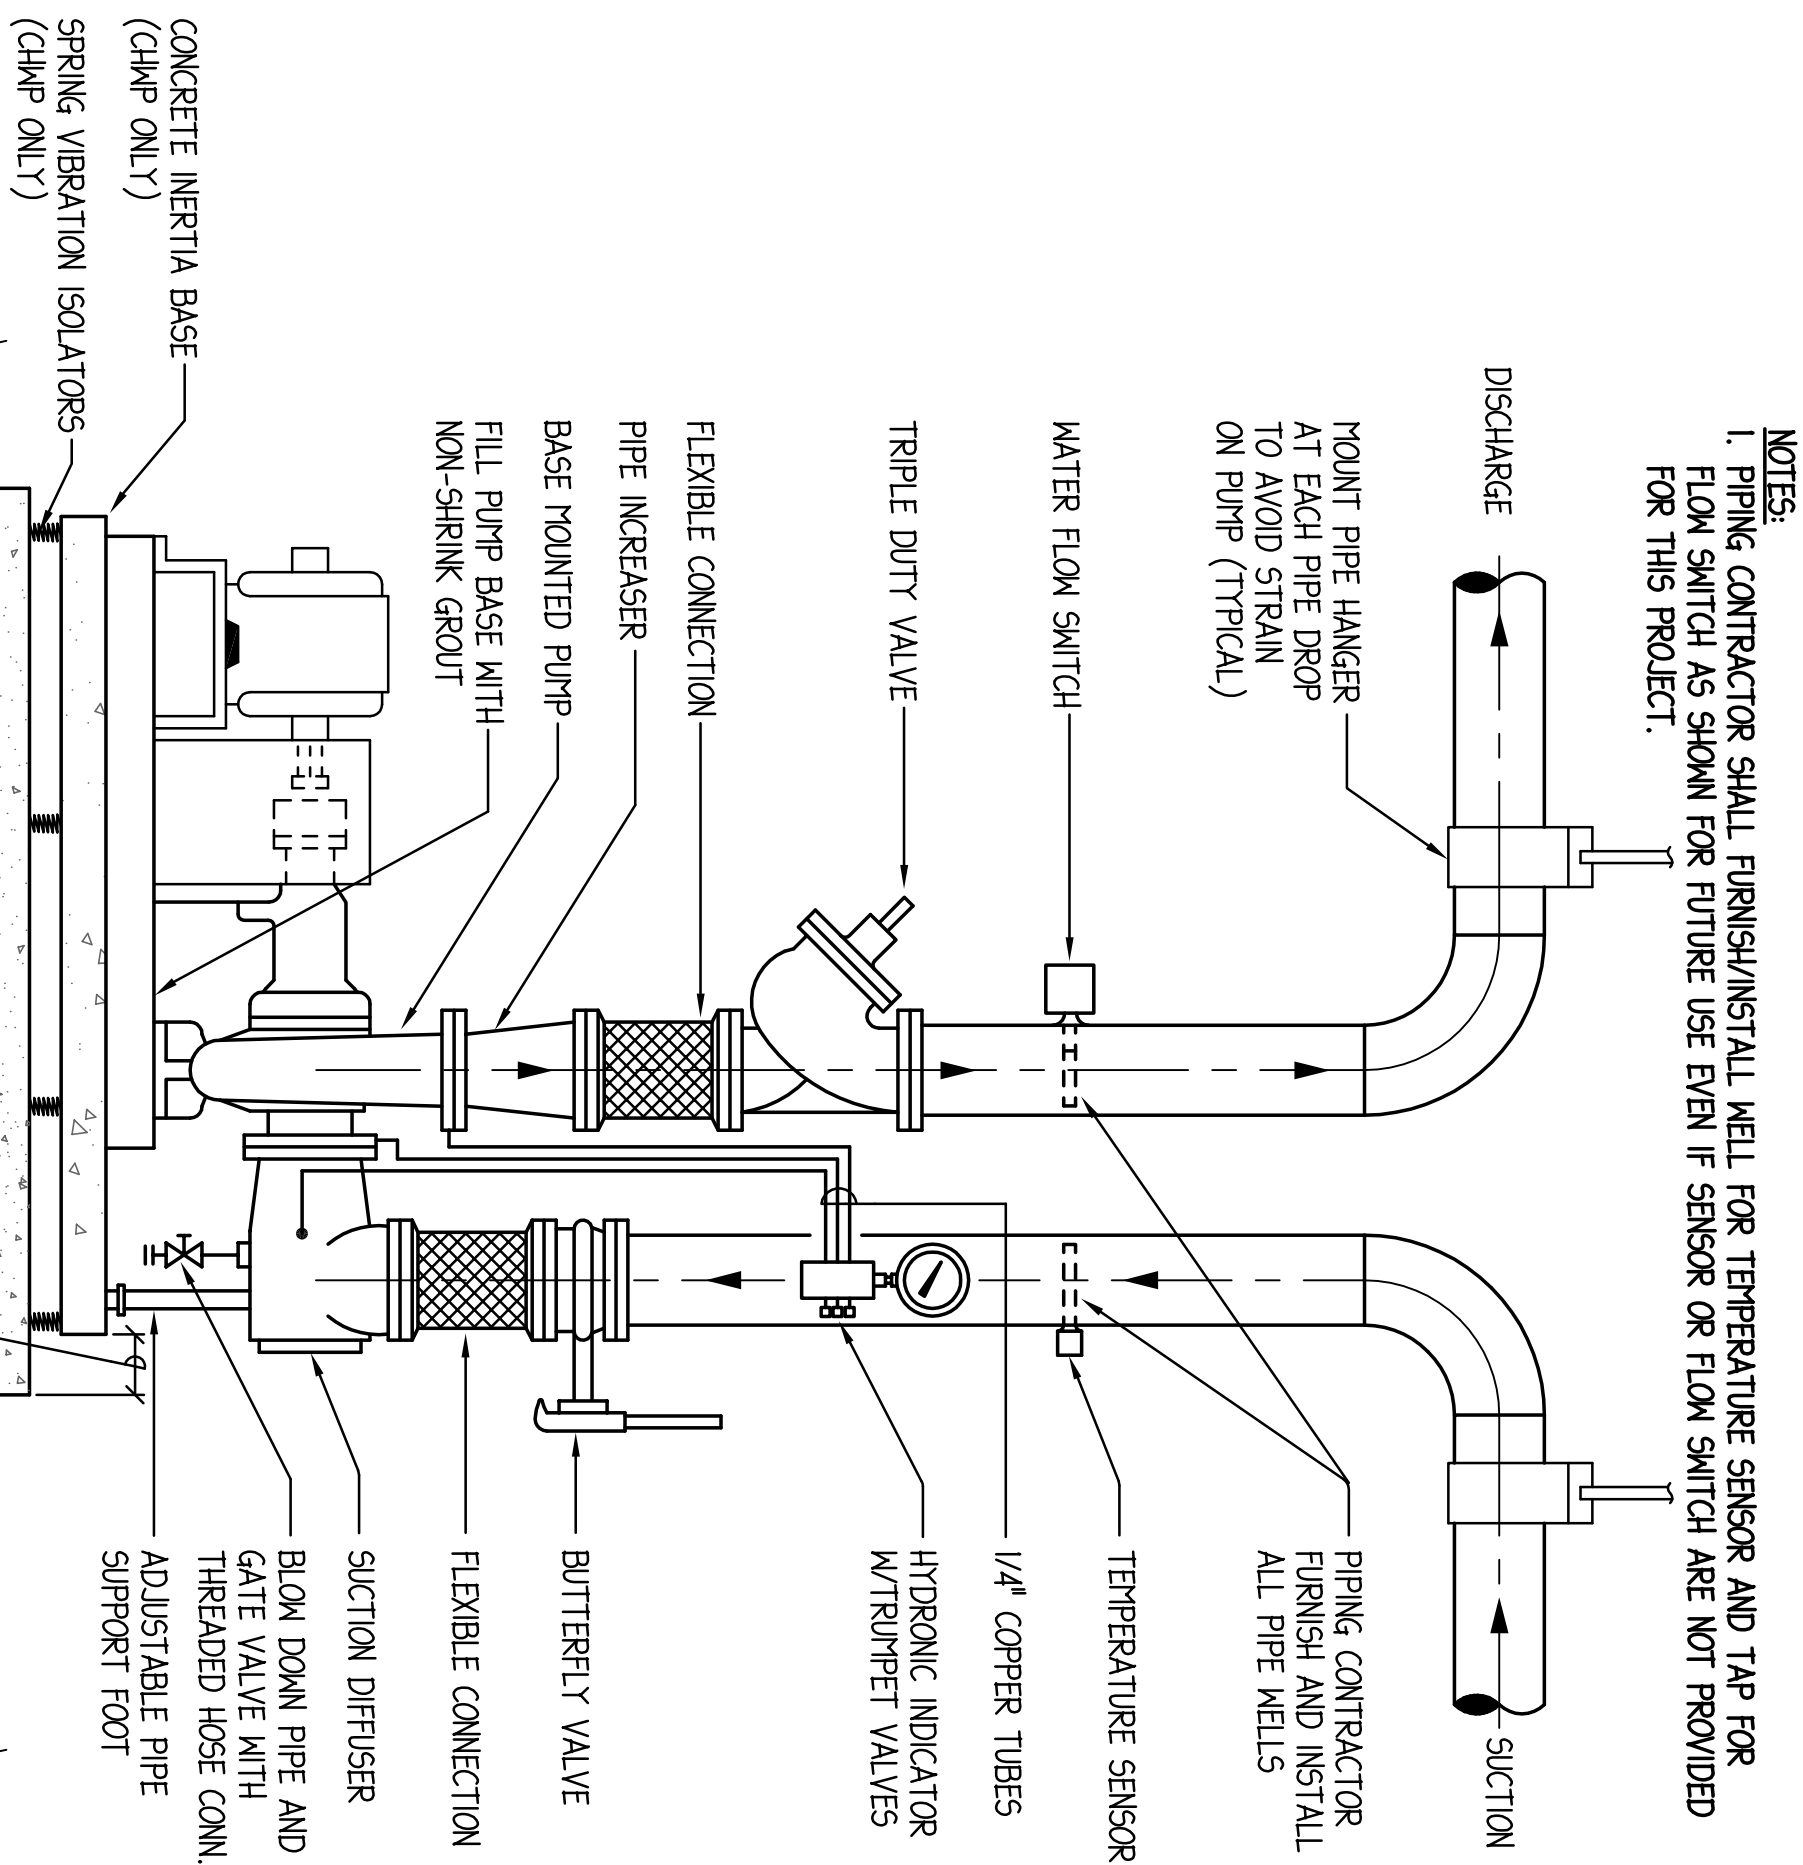

NOTES:
1. PIPING CONTRACTOR SHALL FURNISH/INSTALL WELL FOR TEMPERATURE SENSOR AND TAP FOR FLOW SWITCH AS SHOWN FOR FUTURE USE EVEN IF SENSOR OR FLOW SWITCH ARE NOT PROVIDED FOR THIS PROJECT.

BASE MOUNTED PUMP DETAIL


NO SCALE

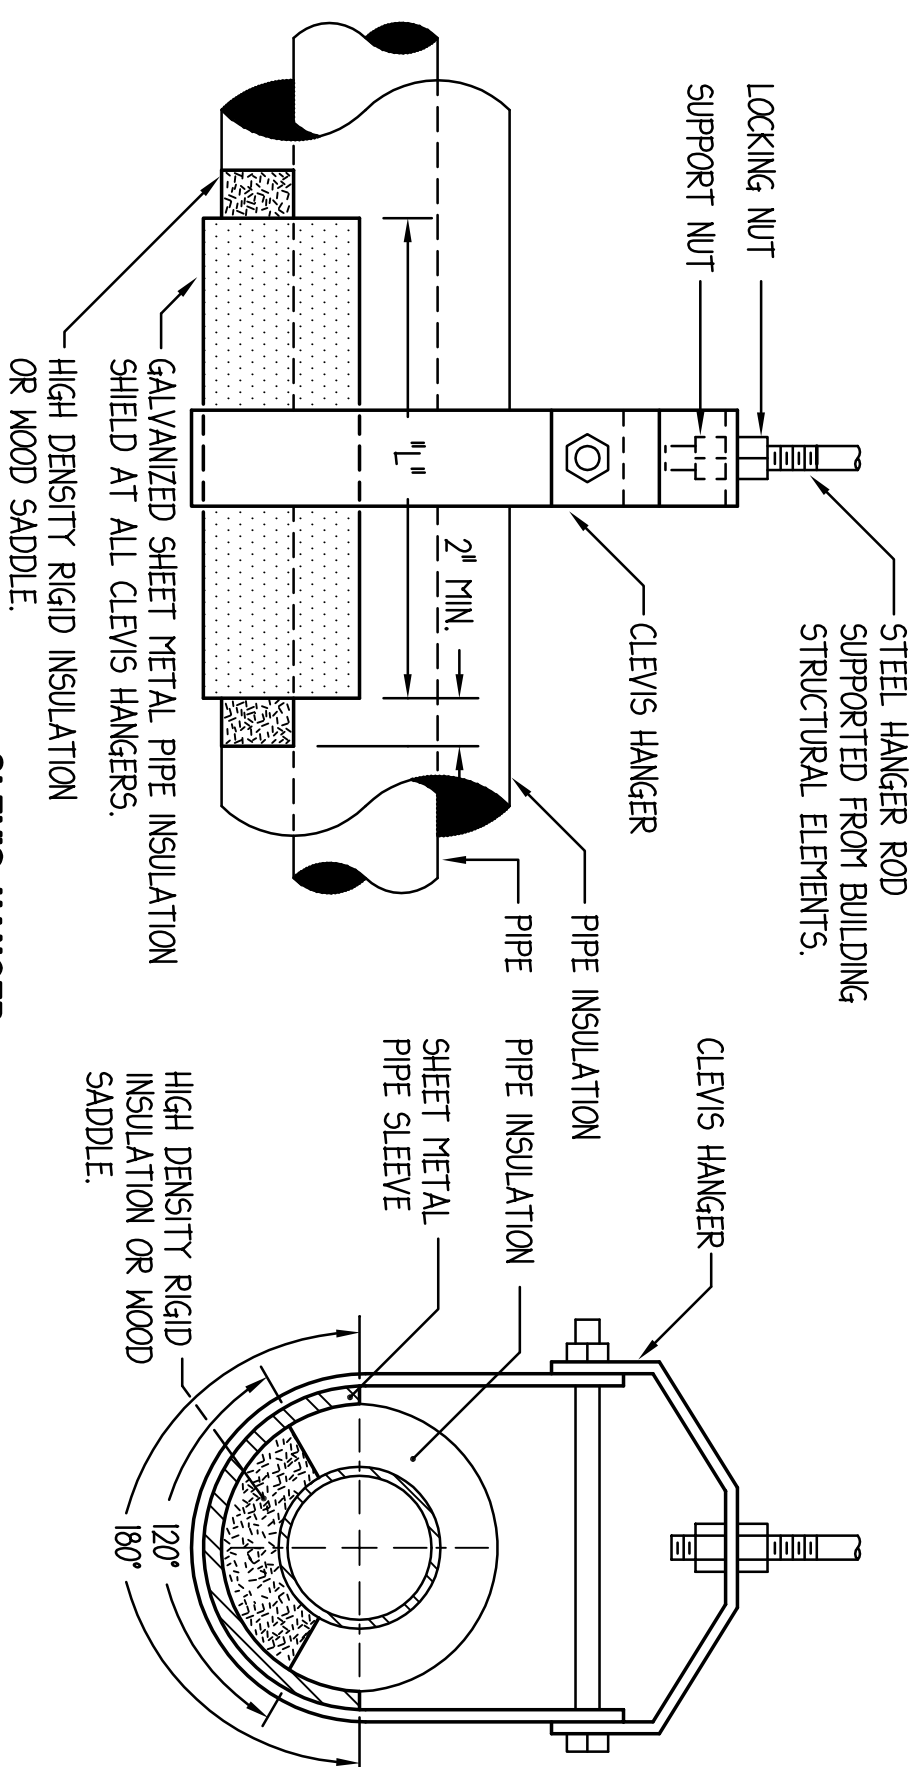

CLEVIS HANGER

PIPE INSULATION SHIELD SCHEDULE		
PIPE SIZE	LENGTH	GALVE
UP TO 3/4"	8'	20 GA.
1" - 2"	12'	18 GA.
2 1/2" - 4"	12'	16 GA.
5" & 6"	18'	16 GA.
8" & UP	24'	14 GA.

NOTE: 1. CONFER WITH ARCHITECT AND REFER TO STRUCTURAL DRAWINGS FOR ADDITIONAL INFORMATION ON ACCEPTABLE METHODS AND LOCATIONS FOR HANGER SUPPORTS.

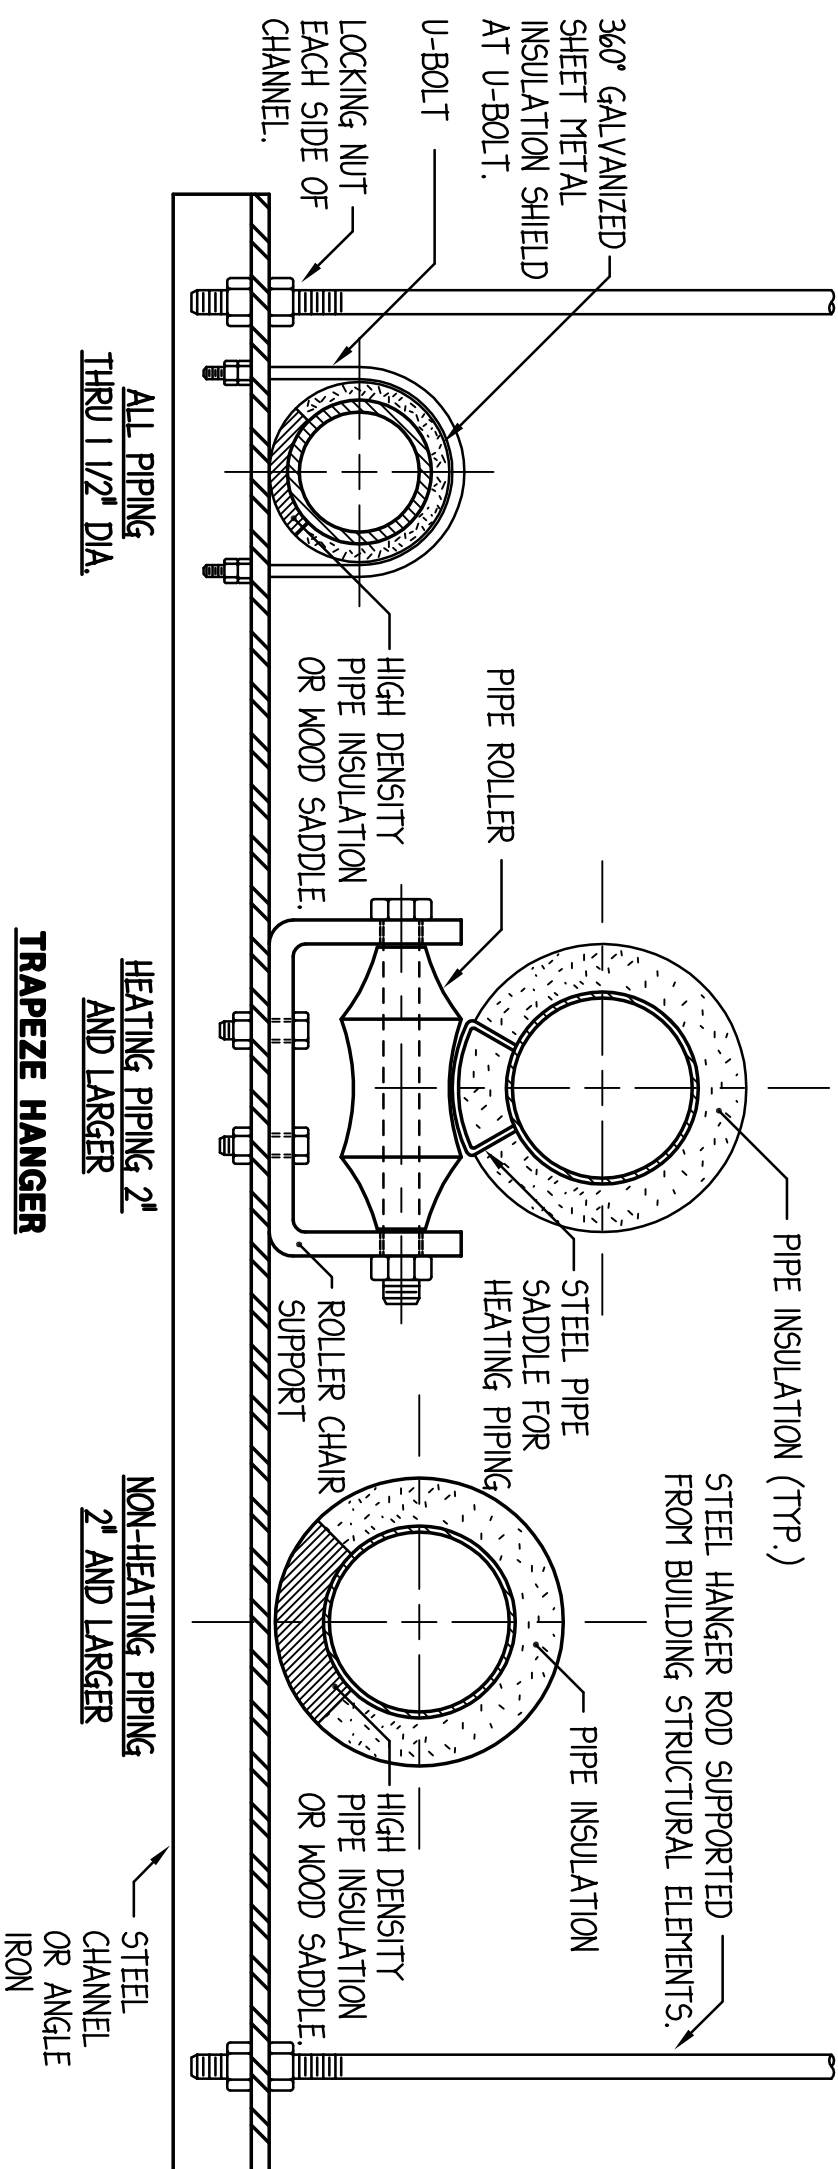

TYPICAL PIPE HANGER DETAILS

NO SCALE

CHILLER/HEATER SCHEDULE														
GENERAL					COMPRESSORS					EVAPORATOR				
EQUIPMENT TAG	LOCATION	AREA SERVED	MANUFACTURER	MODEL	TYPE	DESIGN DUTY (TONS)	REF. TYPE	CHILLER MODULES	NO. EACH	TONS CAPACITY	MIN. CIRCUIT CONFIG.	CIRCUIT CHANGE	ENT. (°F)	EXIT (°F)
CH-1	TECH ROOM	BUILDING B	MULTISTACK	HS550	MODULAR WATER COOLED SCROLL	155.1	R-410a	(3) 8 50 TONS	6	25	1/2	DUAL	18 LBS	56.0
CH-2	TECH ROOM	BUILDING B	MULTISTACK	HS550	MODULAR WATER COOLED SCROLL	155.1	R-410a	(3) 8 50 TONS	6	25	1/2	DUAL	18 LBS	56.0
NOTES: 1. OTHER ACCEPTABLE MANUFACTURERS: CLIMACOL, ARCTICOLL.														
2. THE FOLLOWING OPTIONS ARE STANDARD: STAINLESS STEEL EVAPORATOR AND CONDENSER, ELECTRONIC CHILLED WATER CONTROL, CONDENSER/EVAPORATOR SUPPLY HEADER FILTERS, 150 PSI PRESSURE RATED 1/2" NPT VALVES, 1/2" NPT PIPING, 1/2" NPT PIPING, 1/2" NPT PIPING, INSULATION CONTROLS REQUIRED FOR PROPER OPERATION IN A GEOTHERMAL SYSTEM.														
3. PROVIDE THE FOLLOWING FACTORY INSTALLED OPTIONS: LOW TEMPERATURE CHIP.														
4. PROVIDE THE FOLLOWING FIELD INSTALLED ACCESSORIES: (2) TON SWITCHES, 44 AMP SUPPORT RAILS, ACROSTICAL PANELS, AND DSG INTERFACE COMPATIBLE WITH EXISTING SYSTEM.														

OPEN COOLING TOWER SCHEDULE														
EQUIPMENT TAG	LOCATION	MANUFACTURER	MODEL/SERIES NUMBER	TYPE	INDICED DRAFT	DESIGN DUTY (TONS)	OPERATING WEIGHT (LBS)	DESIGN OUTSIDE AIR TEMP. (°F)		WATER DATA		FAN DATA		NOTES
								DB	WB	ENT. (°F)	P.D. (°F)	ENT. (°F)	P.D. (°F)	
CT-1	ROOF	EVAPCO	UT-26-817			300	15,000	45.0	78.0	45.0	2.8	900	PROOF.	2
NOTES: 1. OTHER ACCEPTABLE MANUFACTURERS: BAC, MARLEY.														
2. PROVIDE THE FOLLOWING OPTIONS AND ACCESSORIES: ENTIRE TOWER TO BE CONSTRUCTED OF 304 STAINLESS OR GALVANIZED STEEL, MAKE-UP BRASS FLOAT ASSEMBLY, PAN STRAINER, IBC COMPLIANT UP TO 16, MOTOR DAVIT AND BASE, 304 STAINLESS STEEL COLD WATER BASIN, EXTERNAL SERVICE PLATFORM WITH LADDER, LADDER EXTENSION, LADDER SAFETY CAGE, SUPER LOW SOUND FANS, WATER SILENCERS, INVERTER CAPABLE PREMIUM EFFICIENT MOTORS, BOTTOM EQUALIZING CONNECTION IN EACH CELL, PULSE-PULSE OR EQUAL CHEMICAL TREATMENT SYSTEM, BLOW DOWN VALVE FOR EACH CELL, AND NEMA 3R FAN VFDs WITH BACRA INTERFACE.														

PUMP SCHEDULE														
EQUIPMENT TAG	LOCATION	SERVICE	MANUFACTURER	MODEL	TYPE	GPM	HEAD (FT.)	1/2" IMR DIA. (IN.)	RPM	MINIMUM EFFICIENCY	TRIPLE DUTY VALVE			NOTES
											TYPE	SIZE	P.D. (FT.)	
CHMP-2	TECH ROOM	CHILLED WATER SYSTEM	TACO	F4075	BASE PUMPED	593	30	6.9	1750	82%	STRAIGHT	5	6.4	7 1/2
CHMP-3	TECH ROOM	CHILLED WATER SYSTEM	TACO	K13007	INLINE	310	18	6.0	1750	58%	STRAIGHT	4	6.1	3
CHMP-4	TECH ROOM	CHILLED WATER SYSTEM	TACO	K13007	INLINE	310	18	6.0	1750	58%	STRAIGHT	4	6.1	3
CHMP-1	TECH ROOM	CONDENSER WATER SYSTEM	TACO	F401C	BASE PUMPED	450	75	9.0	1750	78%	STRAIGHT	5	4.3	15
CHMP-2	TECH ROOM	CONDENSER WATER SYSTEM	TACO	F401C	BASE PUMPED	450	75	9.0	1750	78%	STRAIGHT	5	4.3	15
NOTES: 1. OTHER ACCEPTABLE MANUFACTURERS: BAC, ARISTONOK.														
2. PREMIUM EFFICIENCY MOTORS.														

HYDRONIC ACCESSORIES SCHEDULE											
EQUIPMENT TAG	EQUIPMENT TYPE	LOCATION	SERVICE	MANUFACTURER	MODEL	TYPE	CAPACITY/SIZE	MAXIMUM PRESSURE DROP (FT.)	FILL (PSI)	OPERATING (PSI)	NOTES
AS-CHM	AIR/DIRT SEPARATOR	TECH ROOM	CHILLED WATER SYSTEM	TACO	4989AR-42	TANGENTIAL W/STRAINER	50 GPM, 1" INLET, 8" OUTLET	1.0	--	--	1/2
NOTES: 1. OTHER ACCEPTABLE MANUFACTURERS: BAC, SPINOTHERM.											
2. REMOVABLE MEDIA AND FLANGED OR GROOVED CONNECTIONS.											

VARIABLE FREQUENCY DRIVES														
EQUIPMENT TAG	LOCATION	EQUIPMENT SERVED	MANUFACTURER	MODEL	MOUNTING	SIZE (IN.)			MAX. DRIVE OUTPUT CURRENT	MOTOR			NOTES	
						H	W	D		HP	FREQ. (Hz)	PHASE	VOLT	
VFD-1	TECH ROOM	CHMP-1	TACO	START DRIVE	MALL HOUNDED	18.9 x 9.5 x 10.2			11	7 1/2	1750	60	3	480
VFD-2	TECH ROOM	CHMP-2	TACO	START DRIVE	MALL HOUNDED	18.9 x 9.5 x 10.2			11	7 1/2	1750	60	3	480
NOTES: 1. OTHER ACCEPTABLE MANUFACTURERS: APPROVED EQUAL.														
2. PROVIDE NEMA 1 ENCLOSURE, INPUT DISCONNECT SWITCH, OUTPUT LINE REACTOR, AND BACRA INTERFACE.														

CENTRIFUGAL SEPARATOR SCHEDULE										
EQUIPMENT TAG	LOCATION	UNIT SERVED	MANUFACTURER	MODEL	TYPE	VESSEL SIZE	INLET/OUTLET SIZE	GPM	MAX. P.D. (FT.)	NOTES
CS-1	MECHANICAL ROOM	CH-1	SBS CORP.	CS-500	VERTICAL TANGENTIAL	18" x 53"	5"	450	12.5	1,2,3,4,5,6,7
CS-2	MECHANICAL ROOM	CH-2	SBS CORP.	CS-500	VERTICAL TANGENTIAL	18" x 53"	5"	450	12.5	1,2,3,4,5,6,7
NOTES:										
1. OTHER ACCEPTABLE MANUFACTURERS: LAKOS, PURIFLUX.			5. PURGE OUTLET TO BE COMPLETE WITH CLEAR PVC PIPE AND ELBOW.							
2. INLET/OUTLET PRESSURE GAUGES.			6. NEMA 12 PURGE FREQUENCY/DIRIGATION CONTROL PANEL.							
3. REMOVABLE DOME FOR EASY CLEANOUT.			7. SEPARATOR SHALL REMOVE SEPARABLE SOLIDS LARGER THAN 50 MICRONS.							
4. 4" X 6" INSPECTION PORT.										

BIDDING NOTES:

BASE BID: DELETE THIS SHEET IN IT'S ENTIRETY.
ALT. BID #2: PROVIDE ALL EQUIPMENT SHOWN ON THIS SHEET.

Consultants:

Mechanical - Electrical - Structural Engineers

1216 Tower Road

Schaumburg, Illinois 60173

847.882.2010

847.882.2201

Fax 847.882.2201

2020 ENGINEERING GROUP LLC

ALTERNATE BID #2: HVAC SCHEDULES

McHenry County College - Building 'B' Chiller Replacement

8900 US Hwy 14 - Building 'B'

Crystal Lake, Illinois 60012

Revisions:

23 JUNE 2014 - BID DOCUMENTS

Issue Date:

18 JUNE 2014

Drawn By:

20/10

Job Number:


1500-A-3

1. ALL WORK SHALL BE DONE IN ACCORDANCE WITH THE NATIONAL ELECTRICAL CODE AND LOCAL AMENDMENTS.

- INTERIOR LOCATIONS AND GALVANIZED STEEL OR STAINLESS AL EXTERIOR LOCATIONS.
UNISTRUT OR EQUAL.

20A, 2P, 3 WIRE, GROUNDING TYPE, 125V. SPECIFICATION-GRADE, DUPLEX RECEPTACLE NEMA 5-20R
 (CST) (MP)
 INSTALLED IN AEE UNO

- "E" DEVICES RECEPTACLE NEEDED TO CRITICAL BRANCH OF THE DISCHARGE SYSTEM. RECEPTACLE SHALL BE KEPT IN COOK.
- "F" DEVICES RECEPTACLE EQUIPPED WITH INTEGRAL GROUND FAULT CIRCUIT INTERRUPTER.
- "G" DEVICES RECEPTACLE WITH WHITE-N-USE WEATHERPOOF COVER.
- "H" DEVICES TAPER RESISTANT TYPE RECEPTACLE.
- "I" DEVICES ISOLATED GROUND TYPE RECEPTACLE.
- "S" DEVICES RECEPTACLE WITH INTEGRAL SURGE PROTECTIVE DEVICE.
- "M" DEVICES AIR FAULT CIRCUIT INTERRUPTER.

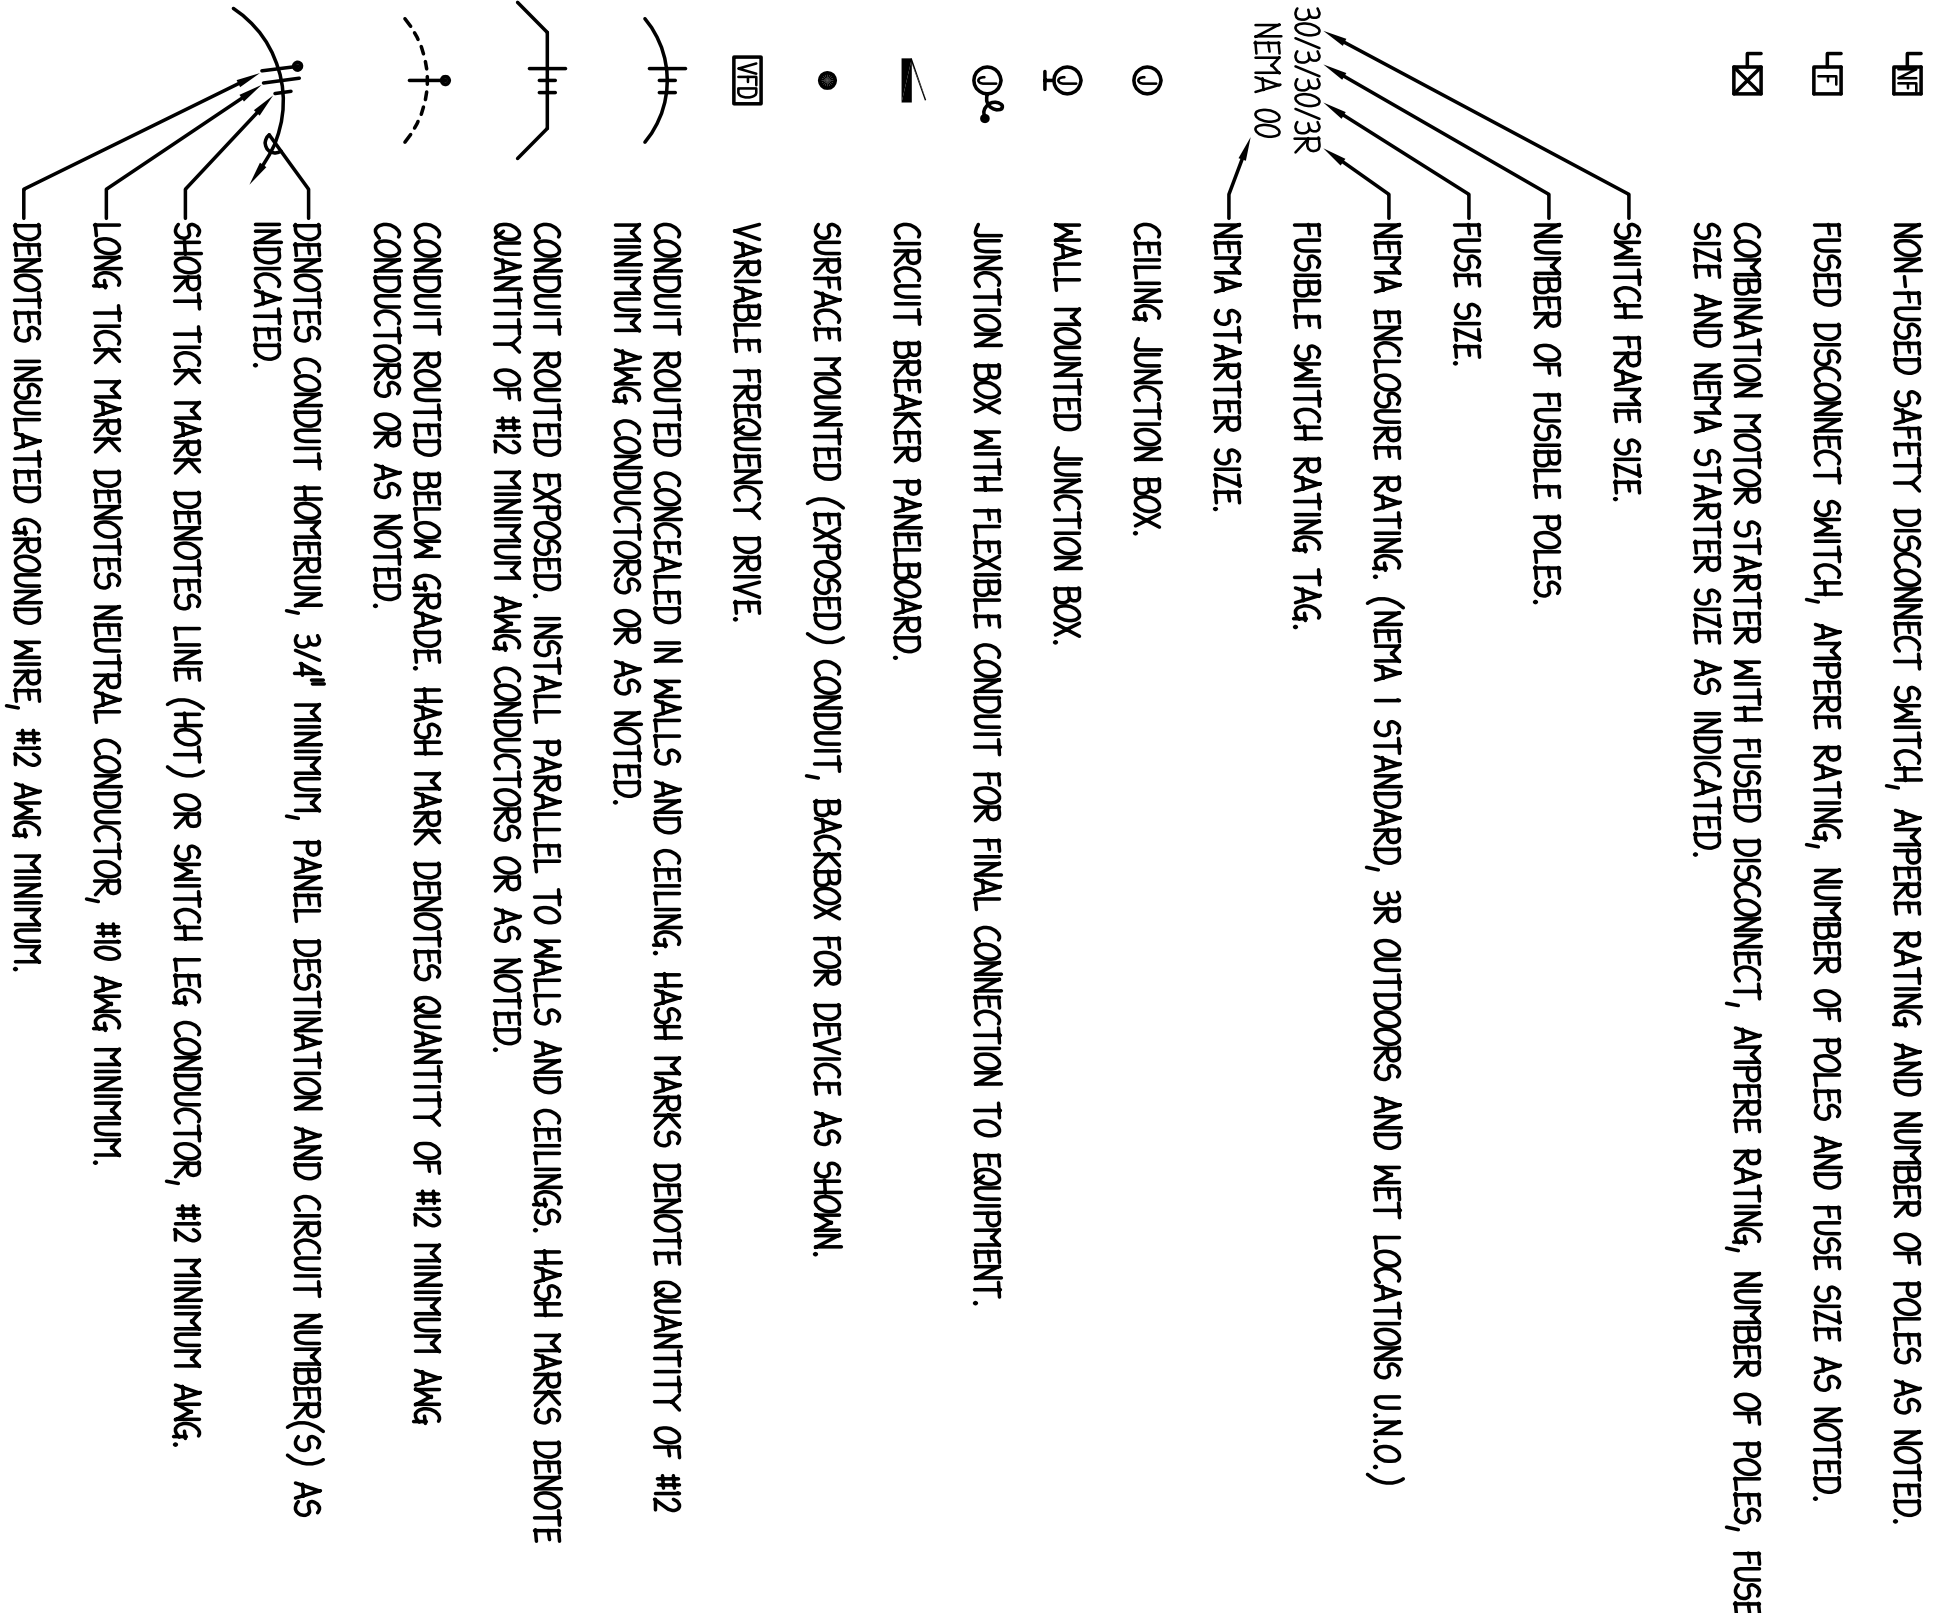

A	AMPERES	HP	HORSEPOWER
---	---------	----	------------

APCI	ARC FAULT CIRCUIT INTERCEPTER	KCH	THOUSAND CIRCULAR MILS
A.F.F.	ABOVE FINISHED FLOOR	MCA	MINIMUM CIRCUIT AMP
C	CONDUIT	V	VOLTS
CT	CURRENT TRANSFORMER	VA	VOLT - AMPERES
CU	COPPER	WP	WEATHER PROOF
EC	ELECTRICAL CONTRACTOR	IP	INGLE POLE
EM	EMERGENCY	2P	TWO POLE
FLA	FULL LOAD AMP	3P	THREE POLE
G, G.RD.	GROUND	Φ	PHASE
GFI	GROUND FAULT CIRCUIT INTERCEPTER		
GFIPI	GROUND FAULT PROTECTIVE EQUIPMENT		

SEE DRAWINGS HV-4 AND HV-5 FOR GENERAL NOTES, AND
ADDITIONAL DETAILS APPLICABLE TO THIS TRADE'S WORK.

INCIDENTAL, IF ANY, ALSO BE NECESSARY, DUE TO CHANGES AFFECTING, SITE WORK, ELECTRICAL, OR OTHER SYSTEMS, SUCH INCIDENTAL WORK IS ALSO PART OF THIS CONTRACT. INSPECT THOSE AREAS, COORDINATE WITH OTHER TRADES, AND ASCERTAIN WORK NEEDED, AND DO THAT WORK IN ACCORD WITH THE CONTRACT REQUIREMENTS, AT NO ADDITIONAL COST. THE REMOVAL, & REINSTALLATION OF EXISTING WORK TO ACCOMMODATE CHANGES TO EXISTING, OR INSTALLATION OF, ELECTRICAL, OTHER SYSTEMS IS ALSO PART OF THIS CONTRACT.

**EL
SP
AN**

2010
ENGINEERING GROUP LLC

Revisions:

23 JUNE 2014 - BID DOCUMENTS

McHenry County College - Building 'B' Chiller Replacement
8900 US Hwy 14 - Building 'B'
Crystal Lake, Illinois 60012

Issue Date: 16 JUNE 2010

Drawn By: 20/MO

Job Number:

4-3